

## TO ALL BIDDERS OF RECORD:

This Addendum forms a part of the Contract Documents and modifies the Drawings and Project Manual as hereinafter indicated.

**1. DEADLINE EXTENSION****\*\* DEADLINE IS EXTENDED TO THE FOLLOWING DATE\*\***

Extended Deadline for **General Construction** is Thursday, October 17, 2024, at 10:00 AM EST

**2. BIDDER QUESTIONS**

1. *This project has liquidated damages. At time of award will the owner work with the contractor to establish an agreeable schedule based on long lead items, and the contractor will not be penalized by liquidated damages for any long lead items that we cannot control delivery on?*

**Response: Yes.**

2. *Will all project testing costs be reimbursed by the owner?*

**Response: The Owner is responsible for third-party inspections per IBC Chapter 17. GC is responsible for permits, regulation inspections and testing. Refer to section 1.15 in 01 10 00 SUMMARY OF WORK, 1.15 PERMITS, INSPECTION, AND TESTING REQUIRED BY GOVERNING AUTHORITIES.**

3. *Please confirm generals are to submit a certification stating that bidder can bond for 100% value of construction. If so, is there a form you can provide?*

**Response: Yes. This form is the surety letter of guarantee from the bidder's bonding company. Refer to section 00 02 00 INSTRUCTIONS TO BIDDERS under Article 4 - Submission of Bids.**

4. *Please confirm electric file sub is responsible for temporary power and lighting.*

**Response: The electrical subcontractor is responsible for providing temporary feeders, while the general contractor is responsible for paying the cost of electric energy consumed by itself and all its subcontractors. Refer to Section 01 50 00 TEMPORARY FACILITIES AND CONTROLS, 1.6 TEMPORARY POWER.**

5. *Will there be a staging area provided onsite for toilets, dumpster, trailers?*

**Response: Yes. Refer to 1/G001, SITE ACCESS CONTROL.**

6. *Please confirm locations of detail 2B/A030? If at entire perimeter, how deep should the cementitious panel be installed?*

**Response: Wall type 2B is at the entire building perimeter. Refer to Typical Wall Section Detail, 1/A500 for the standard depth of the cementitious panel.**

7. *Please confirm that detail 8 on drawing A500 applies to this project. The plywood/blocking shown in this detail are not typical for insulated metal panel roof designs.*

**Response: Omit 8/A500 and replace with issued sketch, SKA-3, as part of this addendum.**

8. *Dedham-Westwood Water District prefabricated canopies. The spec section 05-9995 Prefabricated Canopy calls for two canopies that are supported by one pair of hanger rods. The*

September 27, 2024

*attached alternate product from Upside Innovation has two pairs of hanger rods. Will it be acceptable to carry this product in our base bid? Please confirm.*

**Response: This substitution for Upside prefabricated canopy is acceptable. Product documentation is included as part of this addendum for review.**

### **3. DRAWINGS**

1. **REPLACE** the following drawing sheets labeled addendum 4 dated 9-27-2024:
  - a. A010 CODE REVIEW
  - b. A100 FLOOR PLANS
  - c. S101 FOUNDATION PLAN AND MEZZANINE LEVEL FRAMING PLAN
  - d. E200 ELECTRICAL LIGHTING AND POWER PLANS
2. **REPLACE** the drawings with the following sketches dated 9/27/2024:
  - a. REPLACE drawing 2/A200 with SKA-1 WEST EXTERIOR ELEVATION
  - b. REPLACE drawing 1/A400 with SKA-2 BUILDING SECTION
  - c. REPLACE drawing 8/A500 with SKA-3 SNOW FENCE SECTION
3. On Sheet A900, **REPLACE** 12'-0" WIDTH of DOORS A100.3 and A100.6 to **14'-0"**.

### **1. ATTACHMENTS**

1. A010 CODE REVIEW
2. A100 FLOOR PLANS
3. SKA-1 WEST EXTERIOR ELEVATION
4. SKA-2 BUILDING SECTION
5. SKA-3 SNOW FENCE SECTION
6. S101 FOUNDATION PLAN AND MEZZANINE LEVEL FRAMING PLAN
7. E200 ELECTRICAL LIGHTING AND POWER PLANS
8. Upside prefabricated canopy drawing and specification

(THIS COMPLETES ADDENDUM NO. 4)




## GENERAL PLAN NOTES

1. COORDINATE ALL WORK w/ CIVIL, STRUCTURAL, PLUMBING, MECHANICAL, ELECTRICAL & OTHER DRAWINGS. NOTIFY ARCHITECT OF ANY DISCREPANCIES BEFORE PROCEEDING WITH WORK.
2. ALL DIMENSIONS TO EXTERIOR CONSTRUCTION ARE TO FACE OF CONCRETE FOUNDATION U.N.O.
3. ALL DIMENSIONS TO CONSTRUCTION ARE TO FACE OF STUD
4. ALL EXTERIOR WALLS ARE TYPE  U.N.O.
5. ALL INTERIOR WALLS ARE TYPE  AT STUD WALL U.N.O.
6. ALL DOOR FRAMES SHALL BE A MINIMUM OF 4" CLEAR FROM THE FACE OF ADJACENT WALL TO DOOR JAMB, U.N.O.
7. THE FOLLOWING ITEMS ARE DESIGNATED AS FOLLOWS:  
FE - FIRE EXTINGUISHER WITH SURFACE MOUNTED RETAINER BRACKET
8. REFER TO ENLARGED FLOOR PLANS AND INTERIOR ELEVATIONS FOR ADDITIONAL INFORMATION.
9. ALL TRENCH AND FLOOR DRAINS 1" LOWER THAN MAIN FLOOR LEVELS OR ROOMS. SLOPE ALL SIDES TO DRAIN U.N.O.
10. SLOPED FLOORS SHALL NOT EXCEED 2% SLOPE
11. REFER TO DRAWING G001 FOR ABBREVIATIONS AND SYMBOL DESCRIPTIONS.
12. PROVIDE BLOCKING FOR ALL WALL HUNG ITEMS.

Drawn by ADC  
Checked by AHB, JJR  
Revised on # (DATE) (DESCRIPTION)  
1 3 9-27-2024 ADDENDUM 1 ADDENDUM 4

## CONSTRUCTION LEGEND

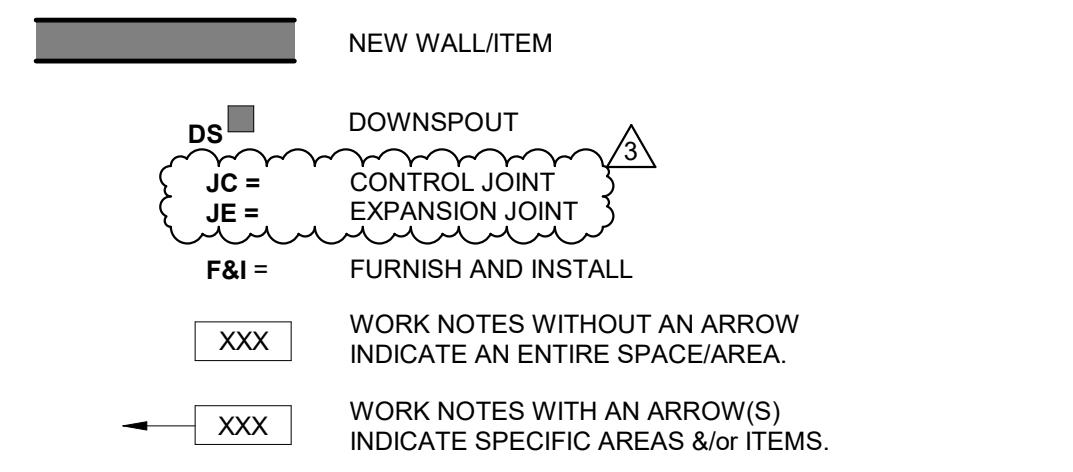


## PLAN WORK NOTES

- A1.1 F&I CONCRETE SIDEWALK W/ TOOLED EDGES AND BROOM FINISH, SLOP AWAY FROM BUILDING FOUNDATION 2% MAX SLOPE; RE: CIVIL DWGS.
- A1.2 F&I CONTROL JOINT SPACED 5'-0" O.C.
- A1.3 F&I 6" DIAMETER 42" HIGH GALV. STEEL BOLLARD FILLED WITH CONCRETE WITH YELLOW COVER SLEEVE; RE: 7/7/501
- A1.4 F&I 3-5/8" METAL STUD & 3/4" MARINE GRADE FRT PLYWOOD, FIELD PAINTED WHITE; RE: 1/4500
- A1.5 F&I NEW METAL STAIR ASSEMBLY RE: ENLARGED DETAILS AND COORDINATE w/ STRUCTURAL DRAWINGS, TYP.
- A1.6 F&I METAL GUARDRAIL, RE: ENLARGED DETAILS AND COORDINATE w/ STRUCTURAL DRAWINGS, TYP.
- A1.7 F&I NEW TRENCH DRAIN AT EACH OVERHEAD DOOR; RE: PLUMBING DWGS.
- A1.9 F&I NEW GAS DETECTION AND FAN CONTROL PANELS; RE: MECHANICAL AND ELECTRICAL DWGS.
- A1.11 F&I NEW PREFAB ALUMINUM CANOPY; RE: 2/4501
- A1.12 F&I NEW OVERHEAD SECTIONAL DOOR WITH PUSHBUTTON; RE: ELECTRICAL DWGS.
- A1.13 F&I EXTERIOR HOSE BIBB; RE: PLUMBING DWGS.
- A1.14 F&I TRAP DRILL BOX; RE: PLUMBING AND ELECTRICAL DWGS.
- A1.15 F&I GAS METER; COORDINATE FINAL LOCATION WITH LOCAL UTILITY COMPANY AND OWNER; RE: PLUMBING DWGS.
- A1.16 F&I FIRE EXTINGUISHER WITH SURFACE MOUNTED RETAINER BRACKET; RE: 13A502
- A1.28 FB 16 GA METAL STUD @ 16" O.C. WITH 5/8" TYPE-X GYPSUM BOARD CHASED THROUGH ROOF FOR PLUMBING STACK AND MECHANICAL DUCT TO ROOF; FIELD PAINT; RE: MECHANICAL AND ELECTRICAL DWGS.

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Project  
**DEDHAM-WESTWOOD  
WATER DISTRICT**

Storage Facility and  
Site Improvements

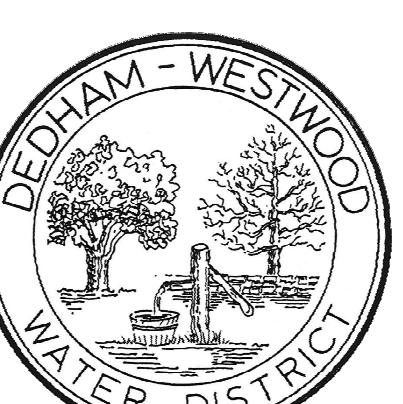

50 ELM STREET  
DEDHAM, MA 02026

Drawing Status  
**100% CONSTRUCTION  
DOCUMENTS**



Issued On 8/20/2024

Sheet Contents  
**FLOOR PLANS**


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Drawing No.

**A100**

Sheet of

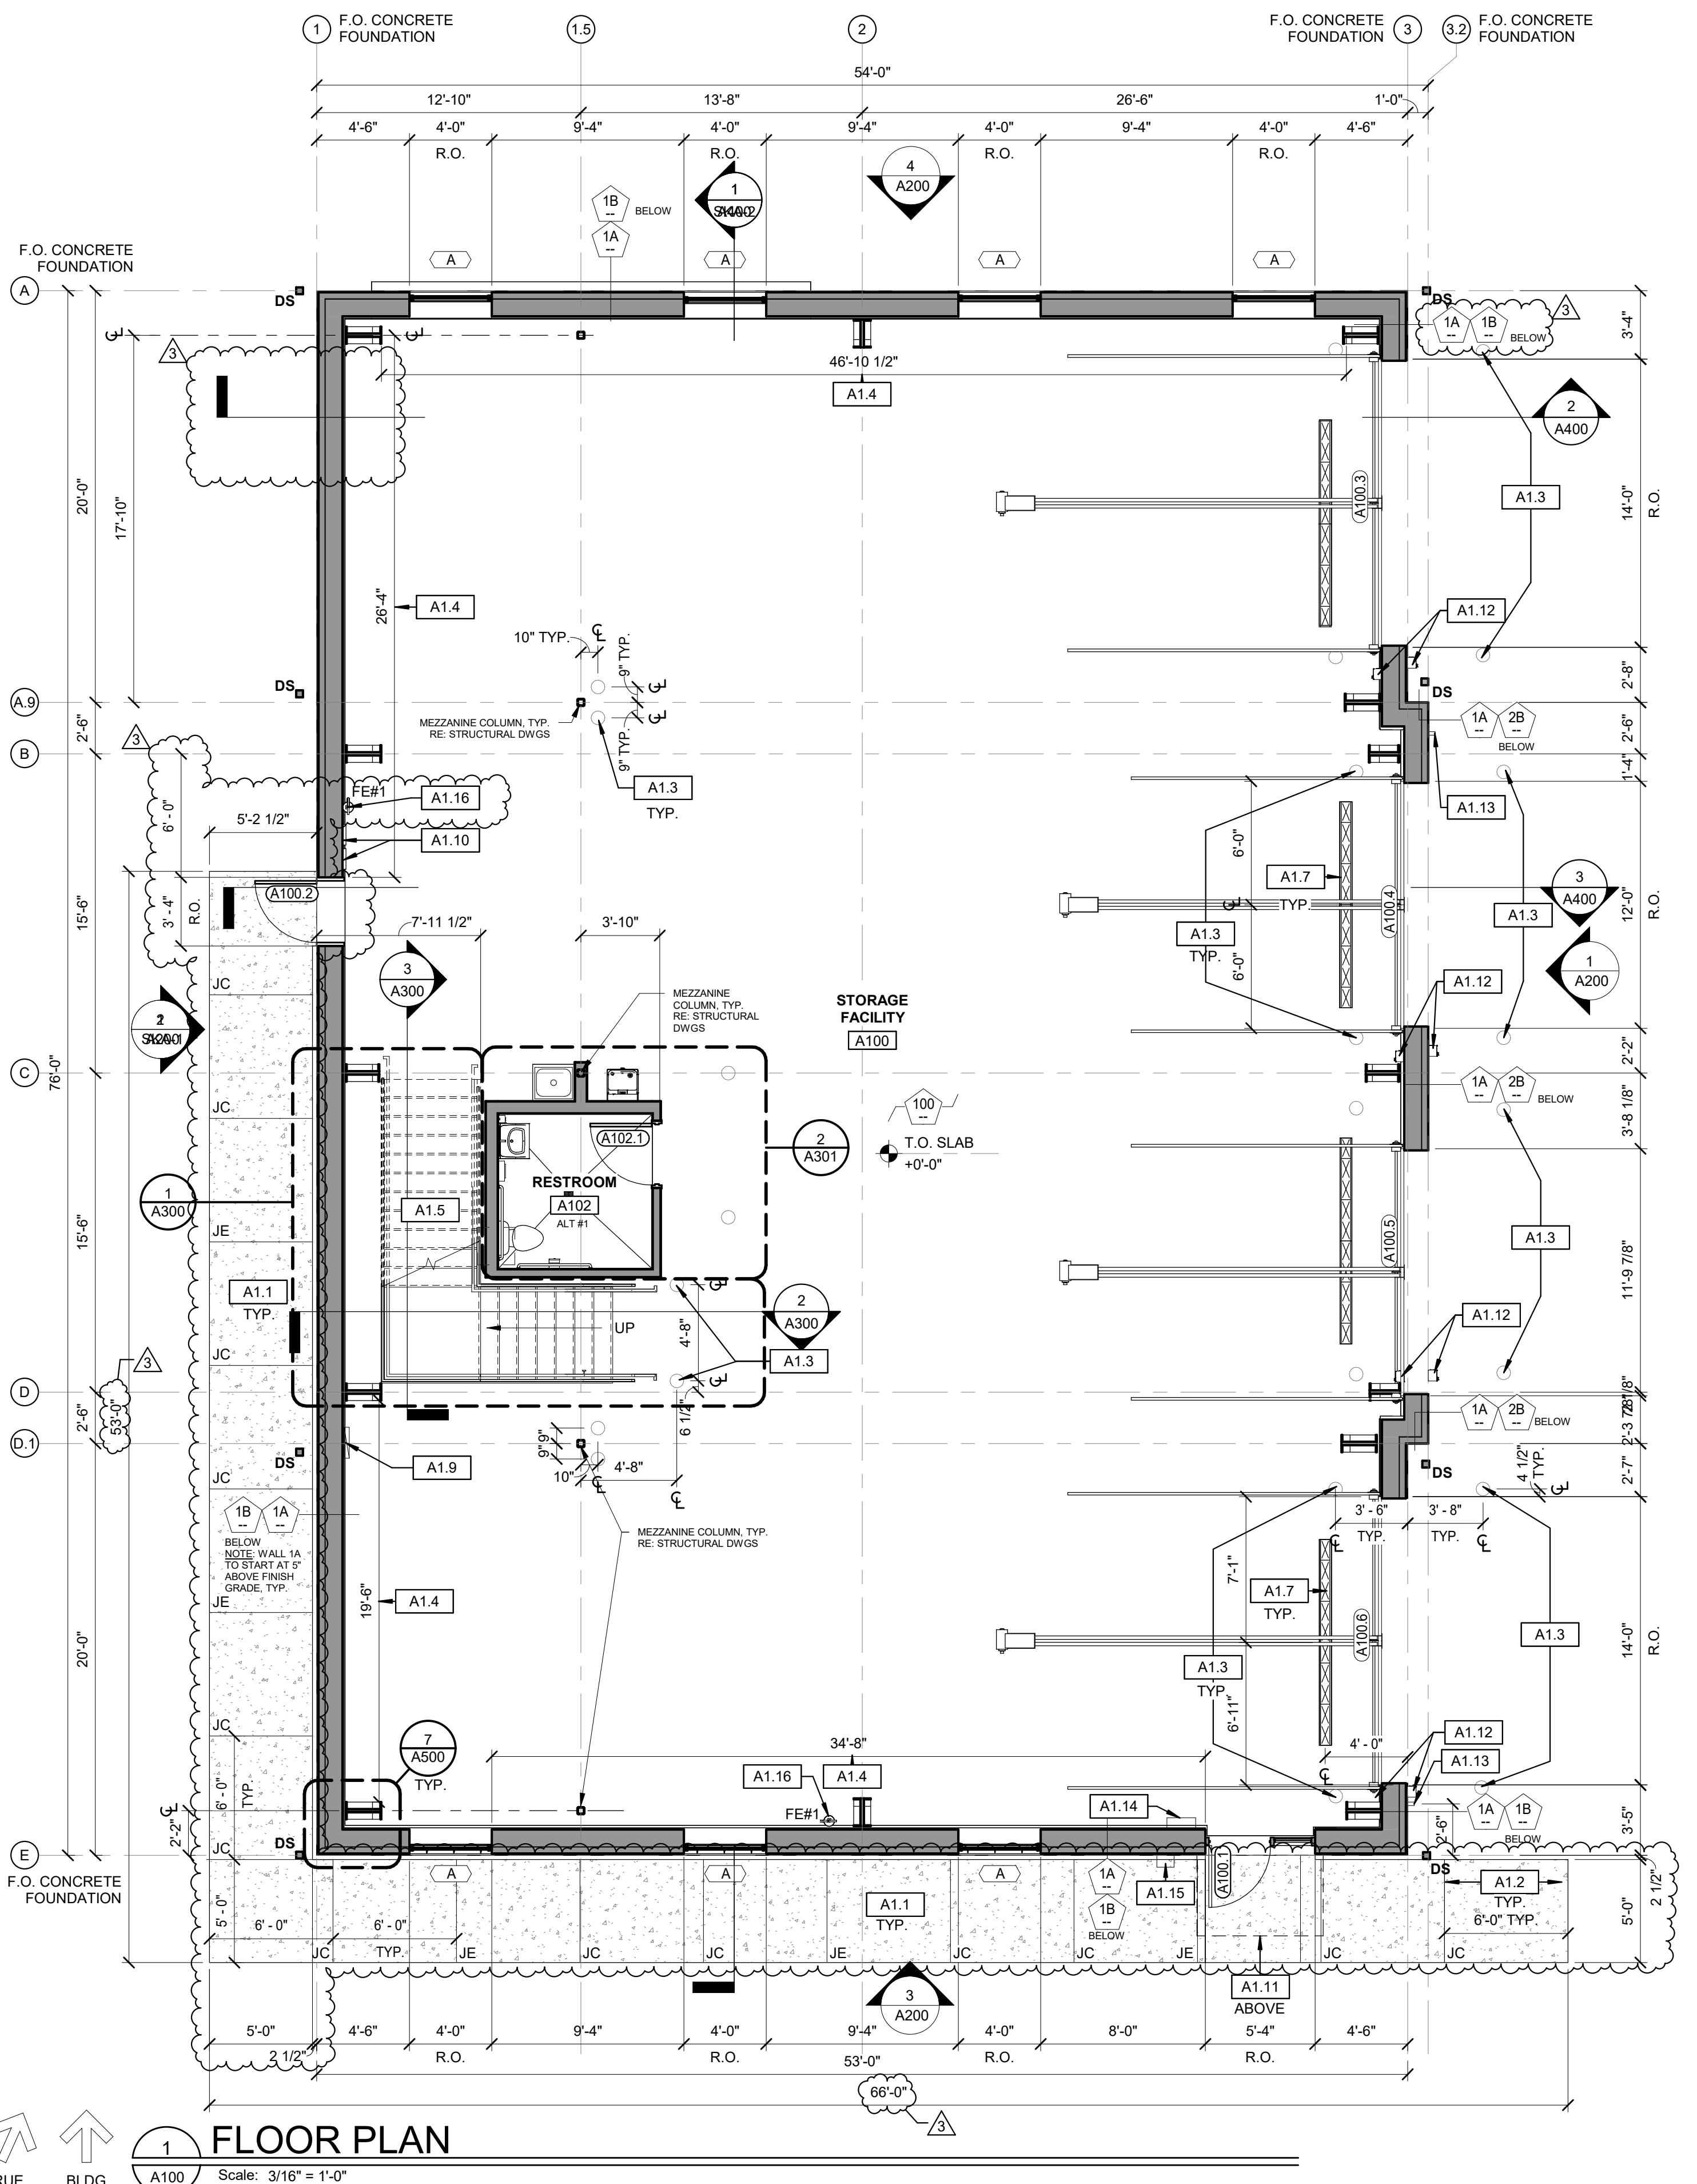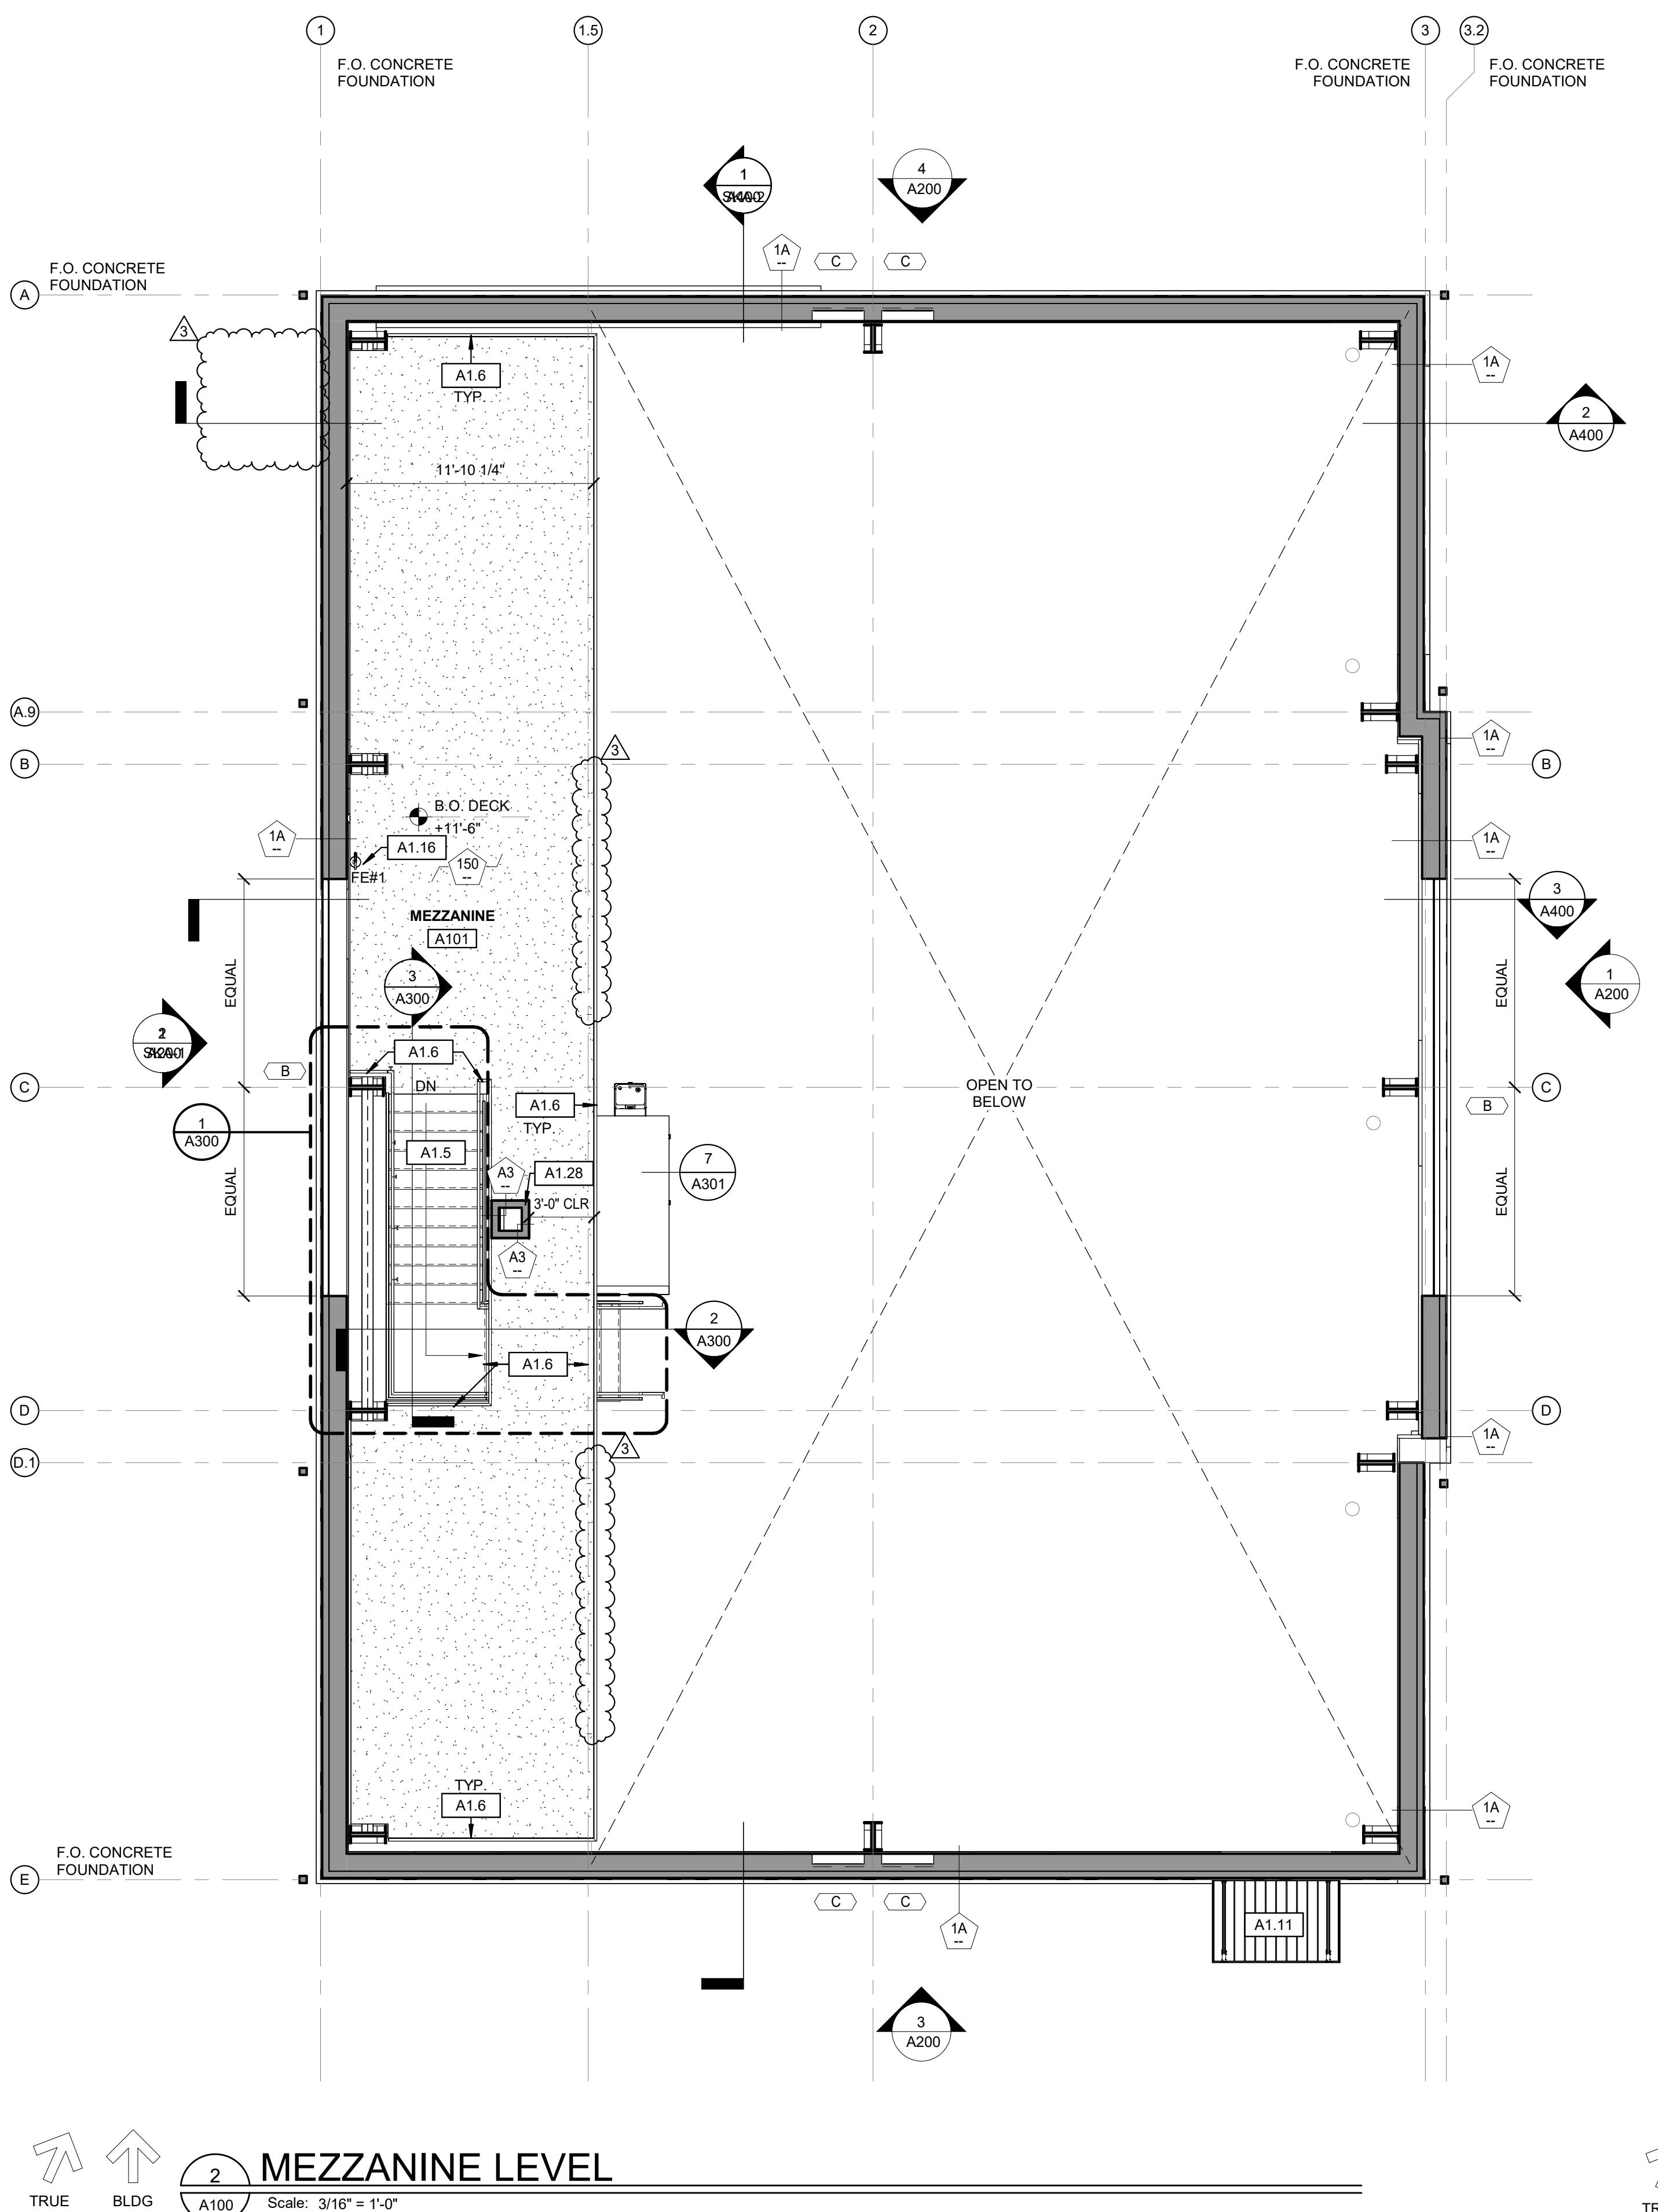

100% CONSTRUCTION DOCUMENTS

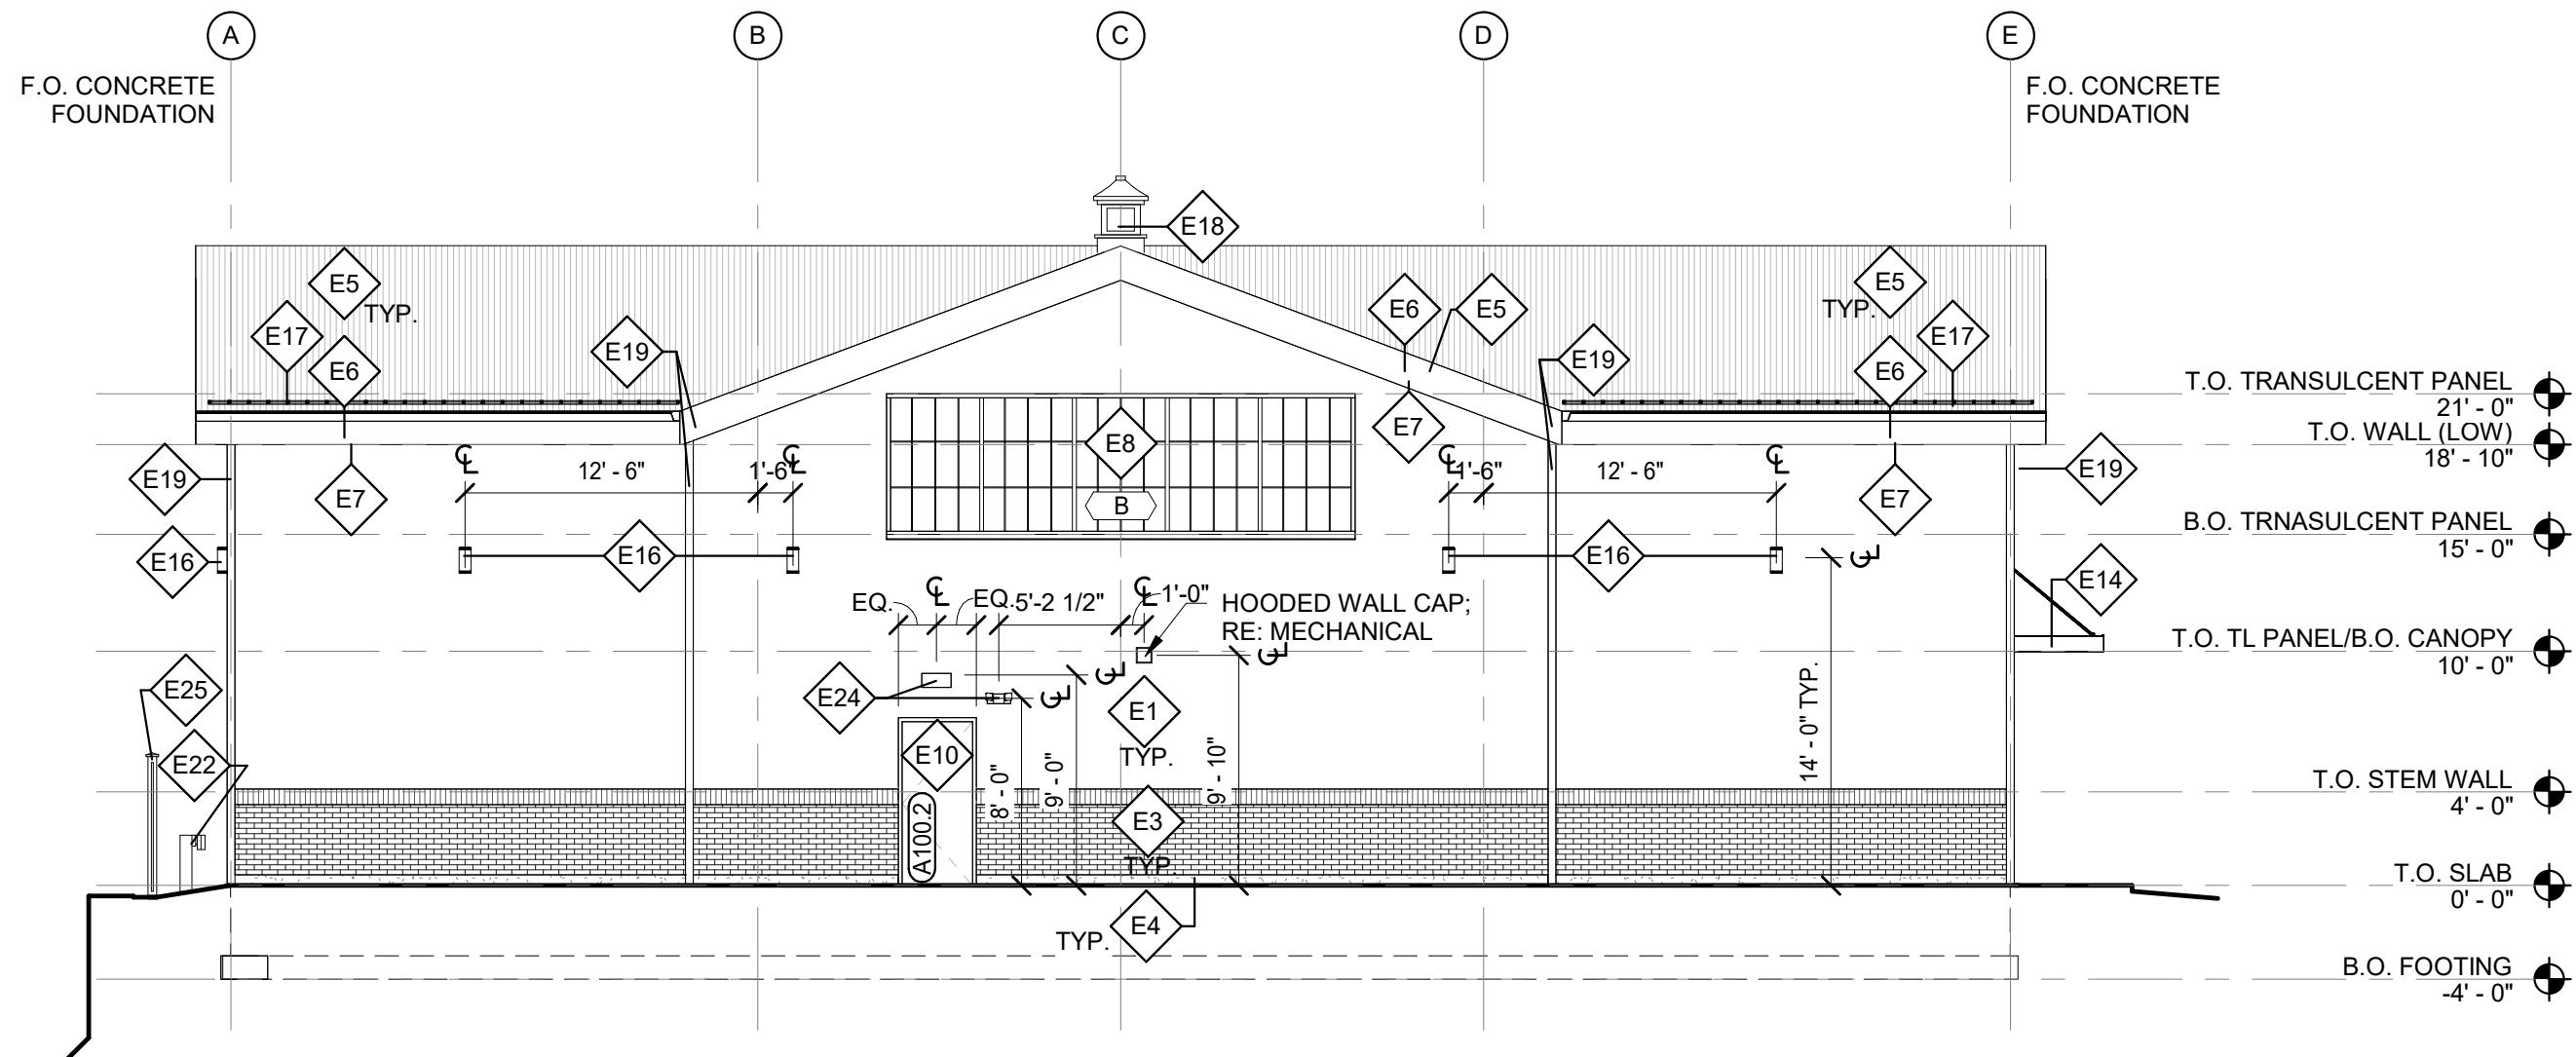

1  
SKA-1

Scale: 1/8" = 1'-0"

## WEST EXTERIOR ELEVATION (SKA-1 ADDEN. #4)

50 Holden Street  
Providence, Rhode Island 02908

Phone: (401) 272-1730  
Fax: (401) 273-7156

E-mail: [rgbinfo@rgb.net](mailto:rgbinfo@rgb.net)  
[www.rgb.net](http://www.rgb.net)




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Project  
STORAGE FACILITY AND  
SITE IMPROVEMENTS

Contents  
**WEST EXTERIOR  
ELEVATION**

|             |          |             |    |
|-------------|----------|-------------|----|
| Project No. | 6790     | Drawing No. |    |
| Checked by  | JRR      | SKA-1       |    |
| Issued      | 09/27/24 | Sheet       | of |

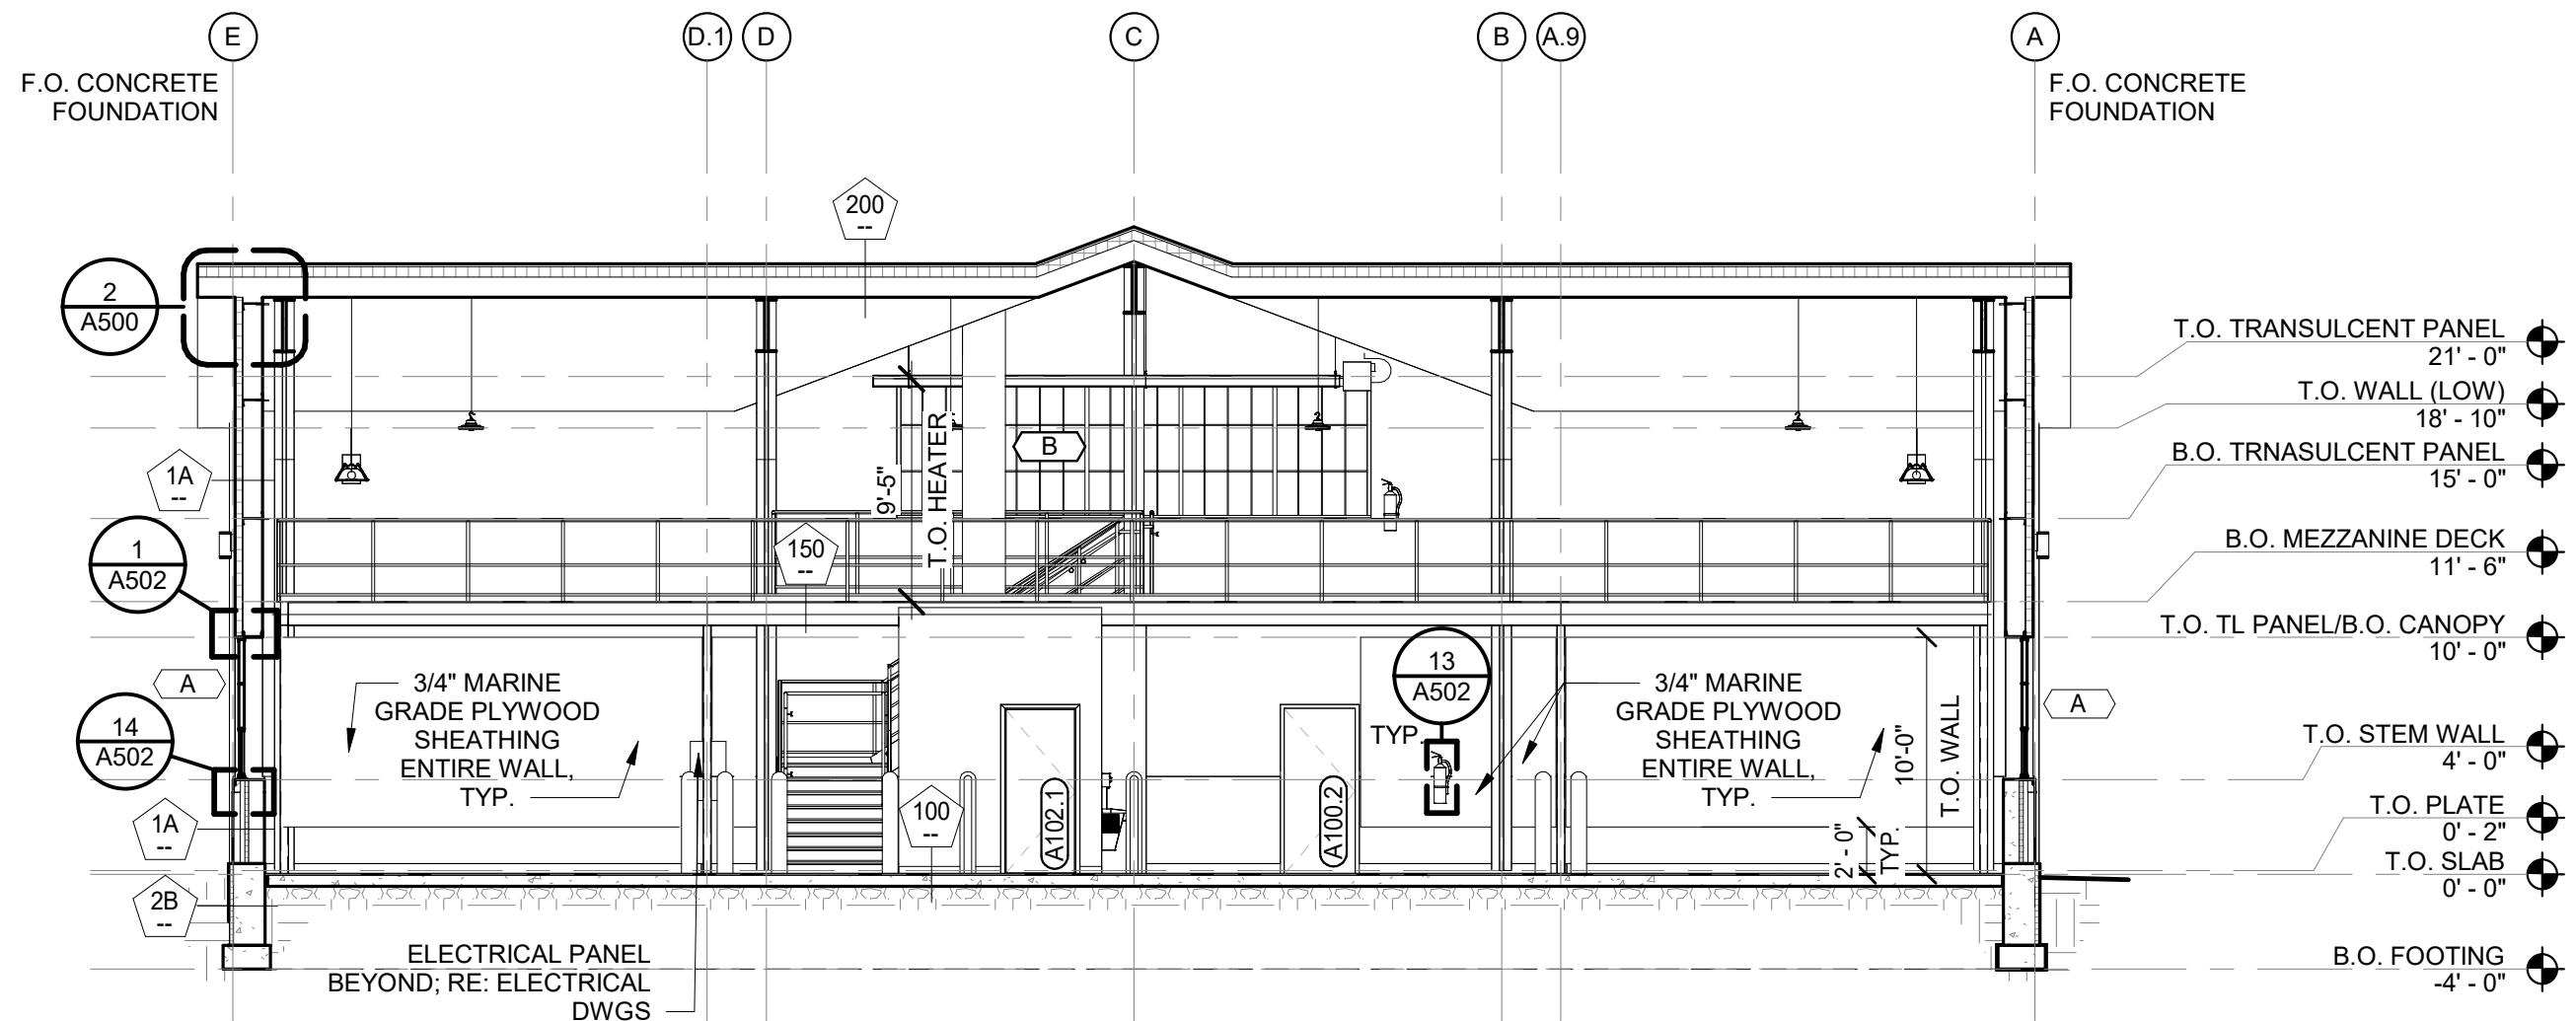

## BUILDING SECTION 1 (SKA-2 ADDEN. #4 )

1  
SKA-2

Scale: 1/8" = 1'-0"

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Phone: (401) 272-1730  
Fax: (401) 273-7156

E-mail: [rgbinfo@rgb.net](mailto:rgbinfo@rgb.net)  
[www.rgb.net](http://www.rgb.net)




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Project  
STORAGE FACILITY AND  
SITE IMPROVEMENTS

Contents  
**BUILDING  
SECTION**

|             |          |             |       |
|-------------|----------|-------------|-------|
| Project No. | 6790     | Drawing No. | SKA-2 |
| Checked by  | JRR      |             |       |
| Issued      | 09/27/24 | Sheet       |       |

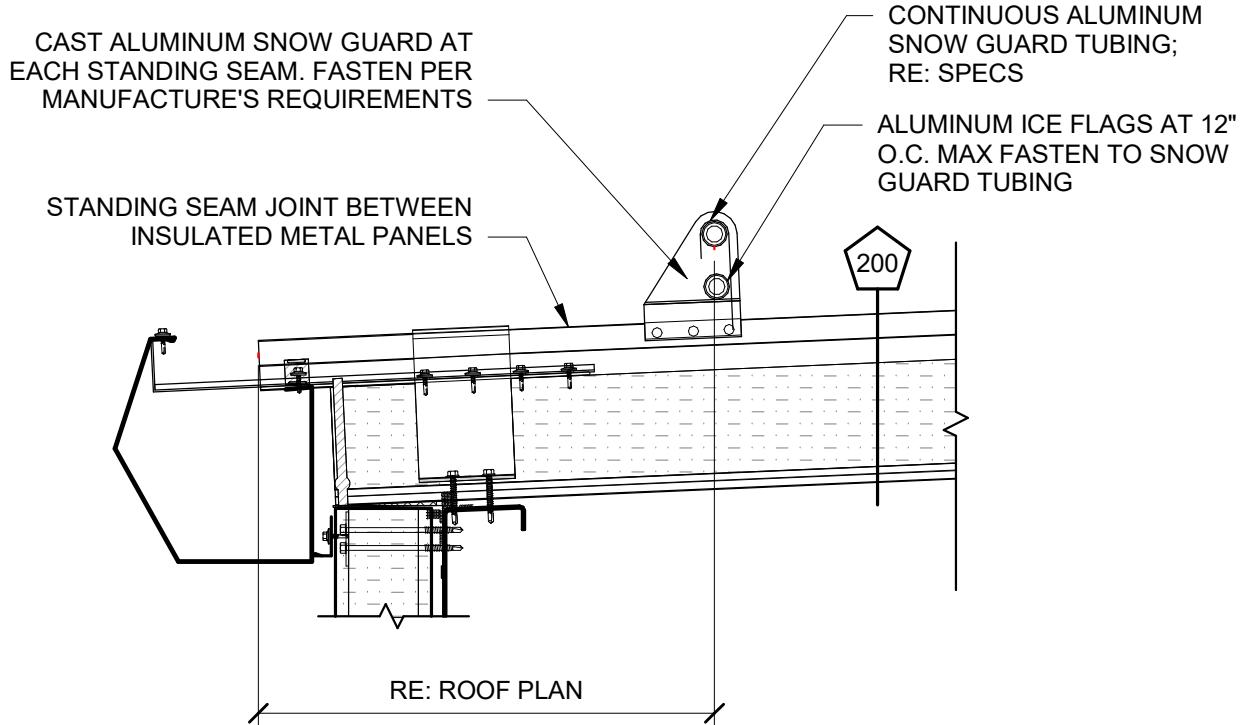

1  
SKA-3

## SNOW FENCE (SKA-3 ADDEN. #4)

Scale: 1 1/2" = 1'-0"

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Providence, Rhode Island 02908

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Fax: (401) 273-7156

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[www.rgb.net](http://www.rgb.net)



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Project


STORAGE FACILITY  
AND SITE  
IMPROVEMENTS

Contents


### SNOW GUARD FENCE DETAIL

|             |          |             |
|-------------|----------|-------------|
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| Checked by  | JRR      | SKA-3       |
| Issued      | 09/27/24 | Sheet of    |


| FOOTING SCHEDULE |               |           |              |
|------------------|---------------|-----------|--------------|
| MARK             | SIZE          | THICKNESS | REINFORCING  |
| F3               | 3'-0" x 3'-0" | 1'-0"     | 4-#5 EA. WAY |
| F4               | 4'-0" x 4'-0" | 1'-0"     | 5-#5 EA. WAY |
| F5               | 5'-0" x 5'-0" | 1'-0"     | 6-#5 EA. WAY |
| F6               | 6'-0" x 6'-0" | 1'-0"     | 7-#5 EA. WAY |
| F8               | 8'-0" x 8'-0" | 1'-0"     | 9-#5 EA. WAY |

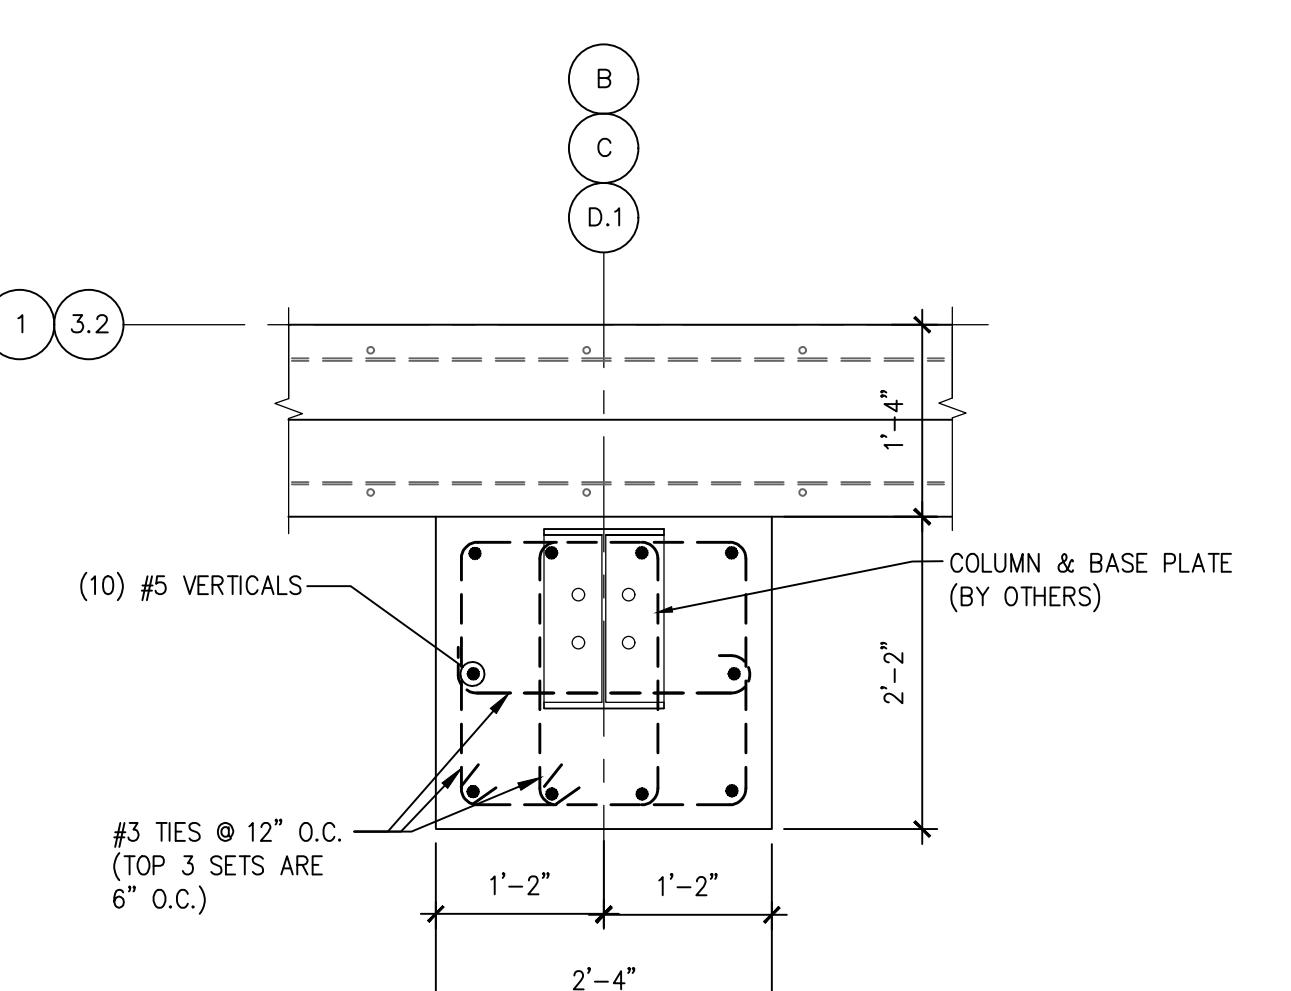


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SCALE: 3/4"=1'-0"

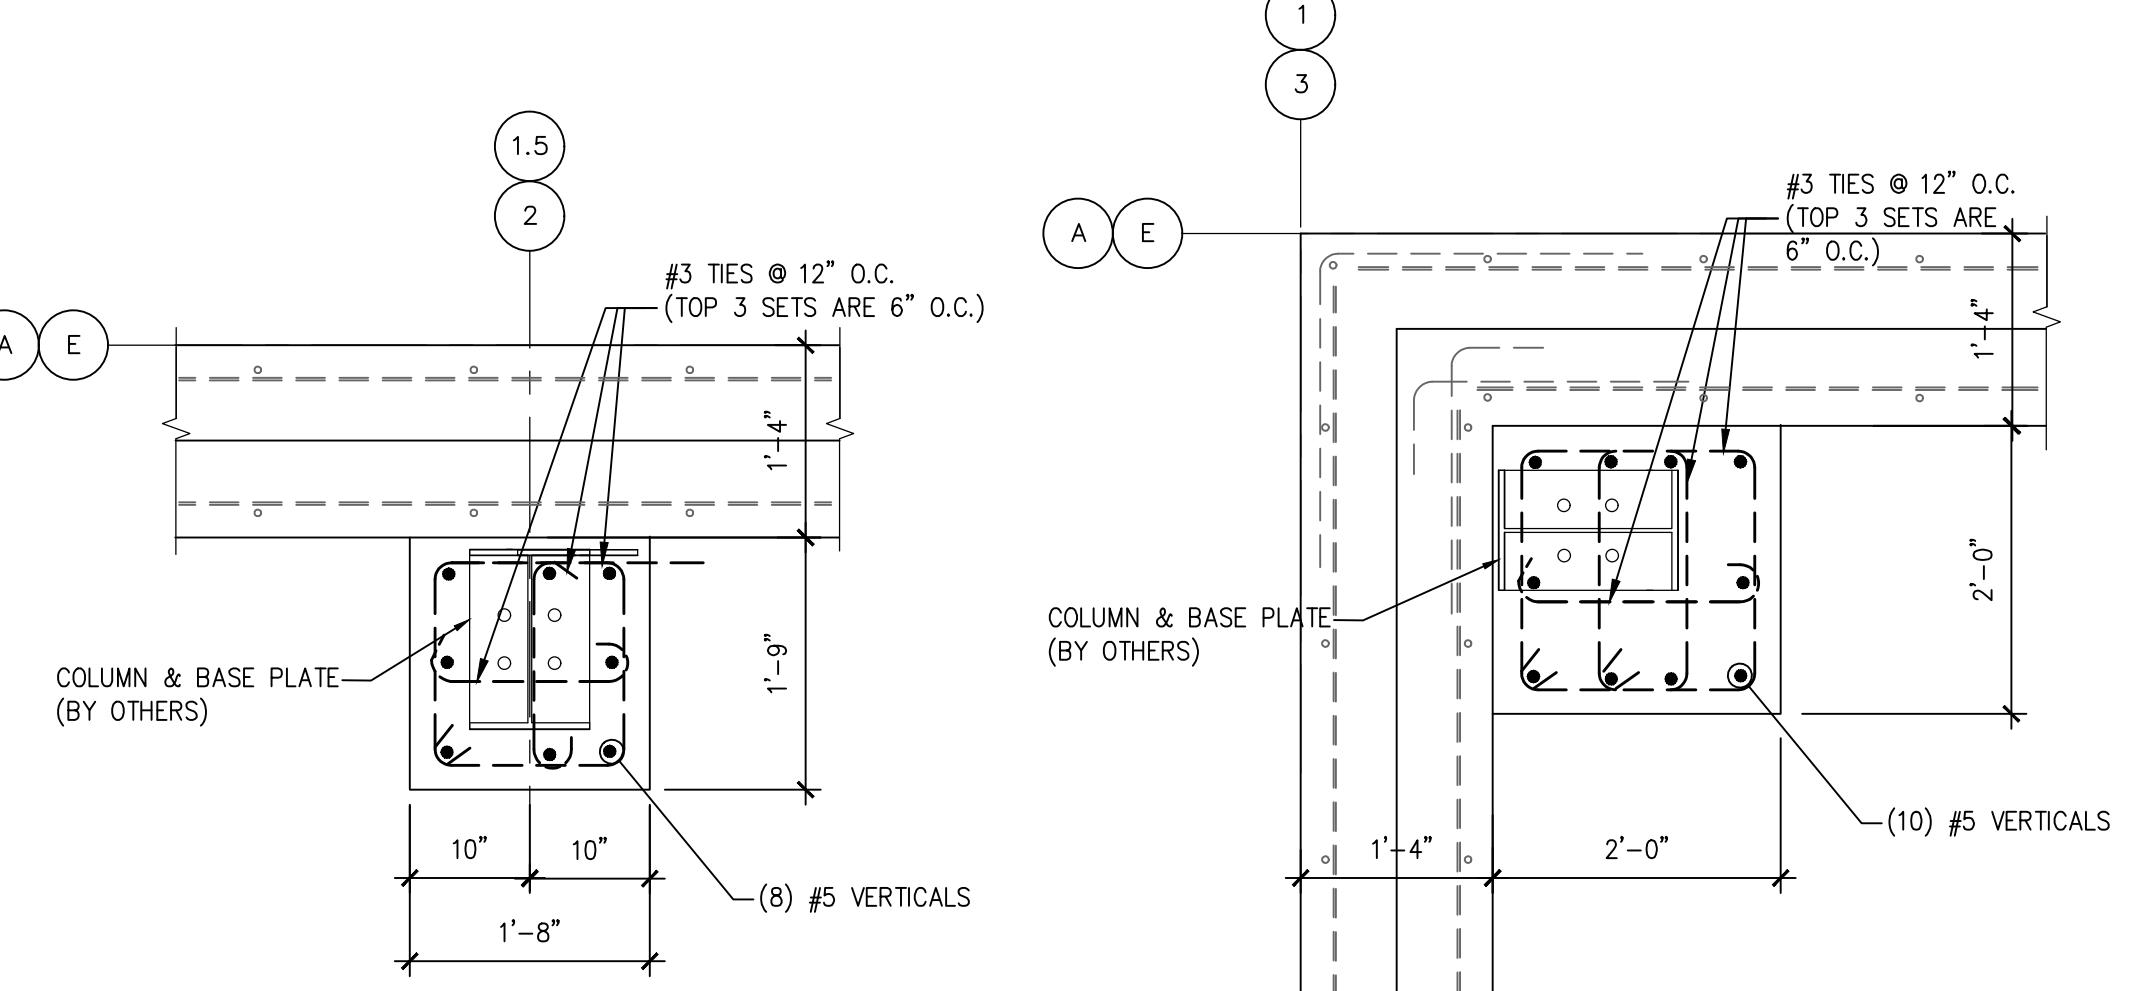

PIER "P2" DETAIL  
SCALE: 3/4"=1'-0"

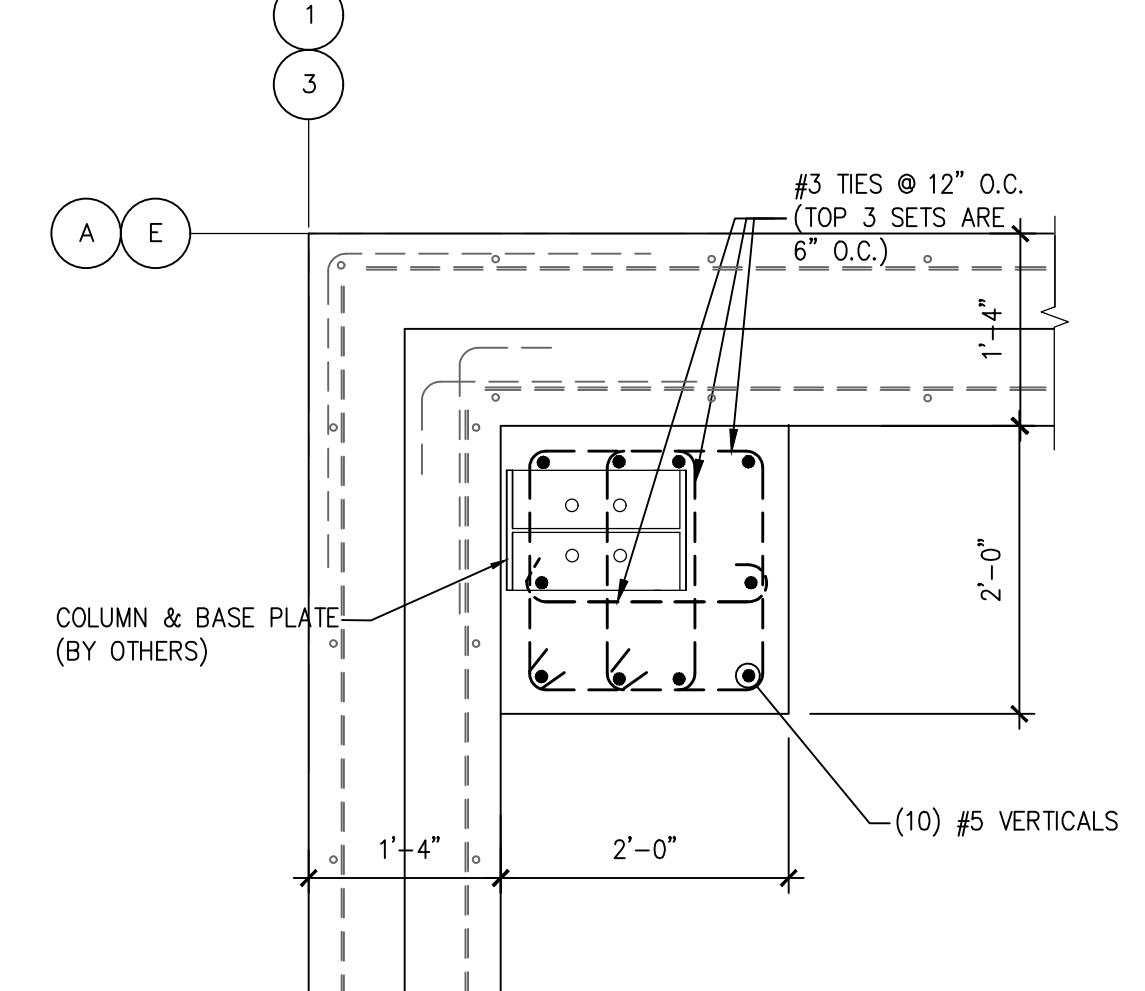


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PIER "P4" DETAIL  
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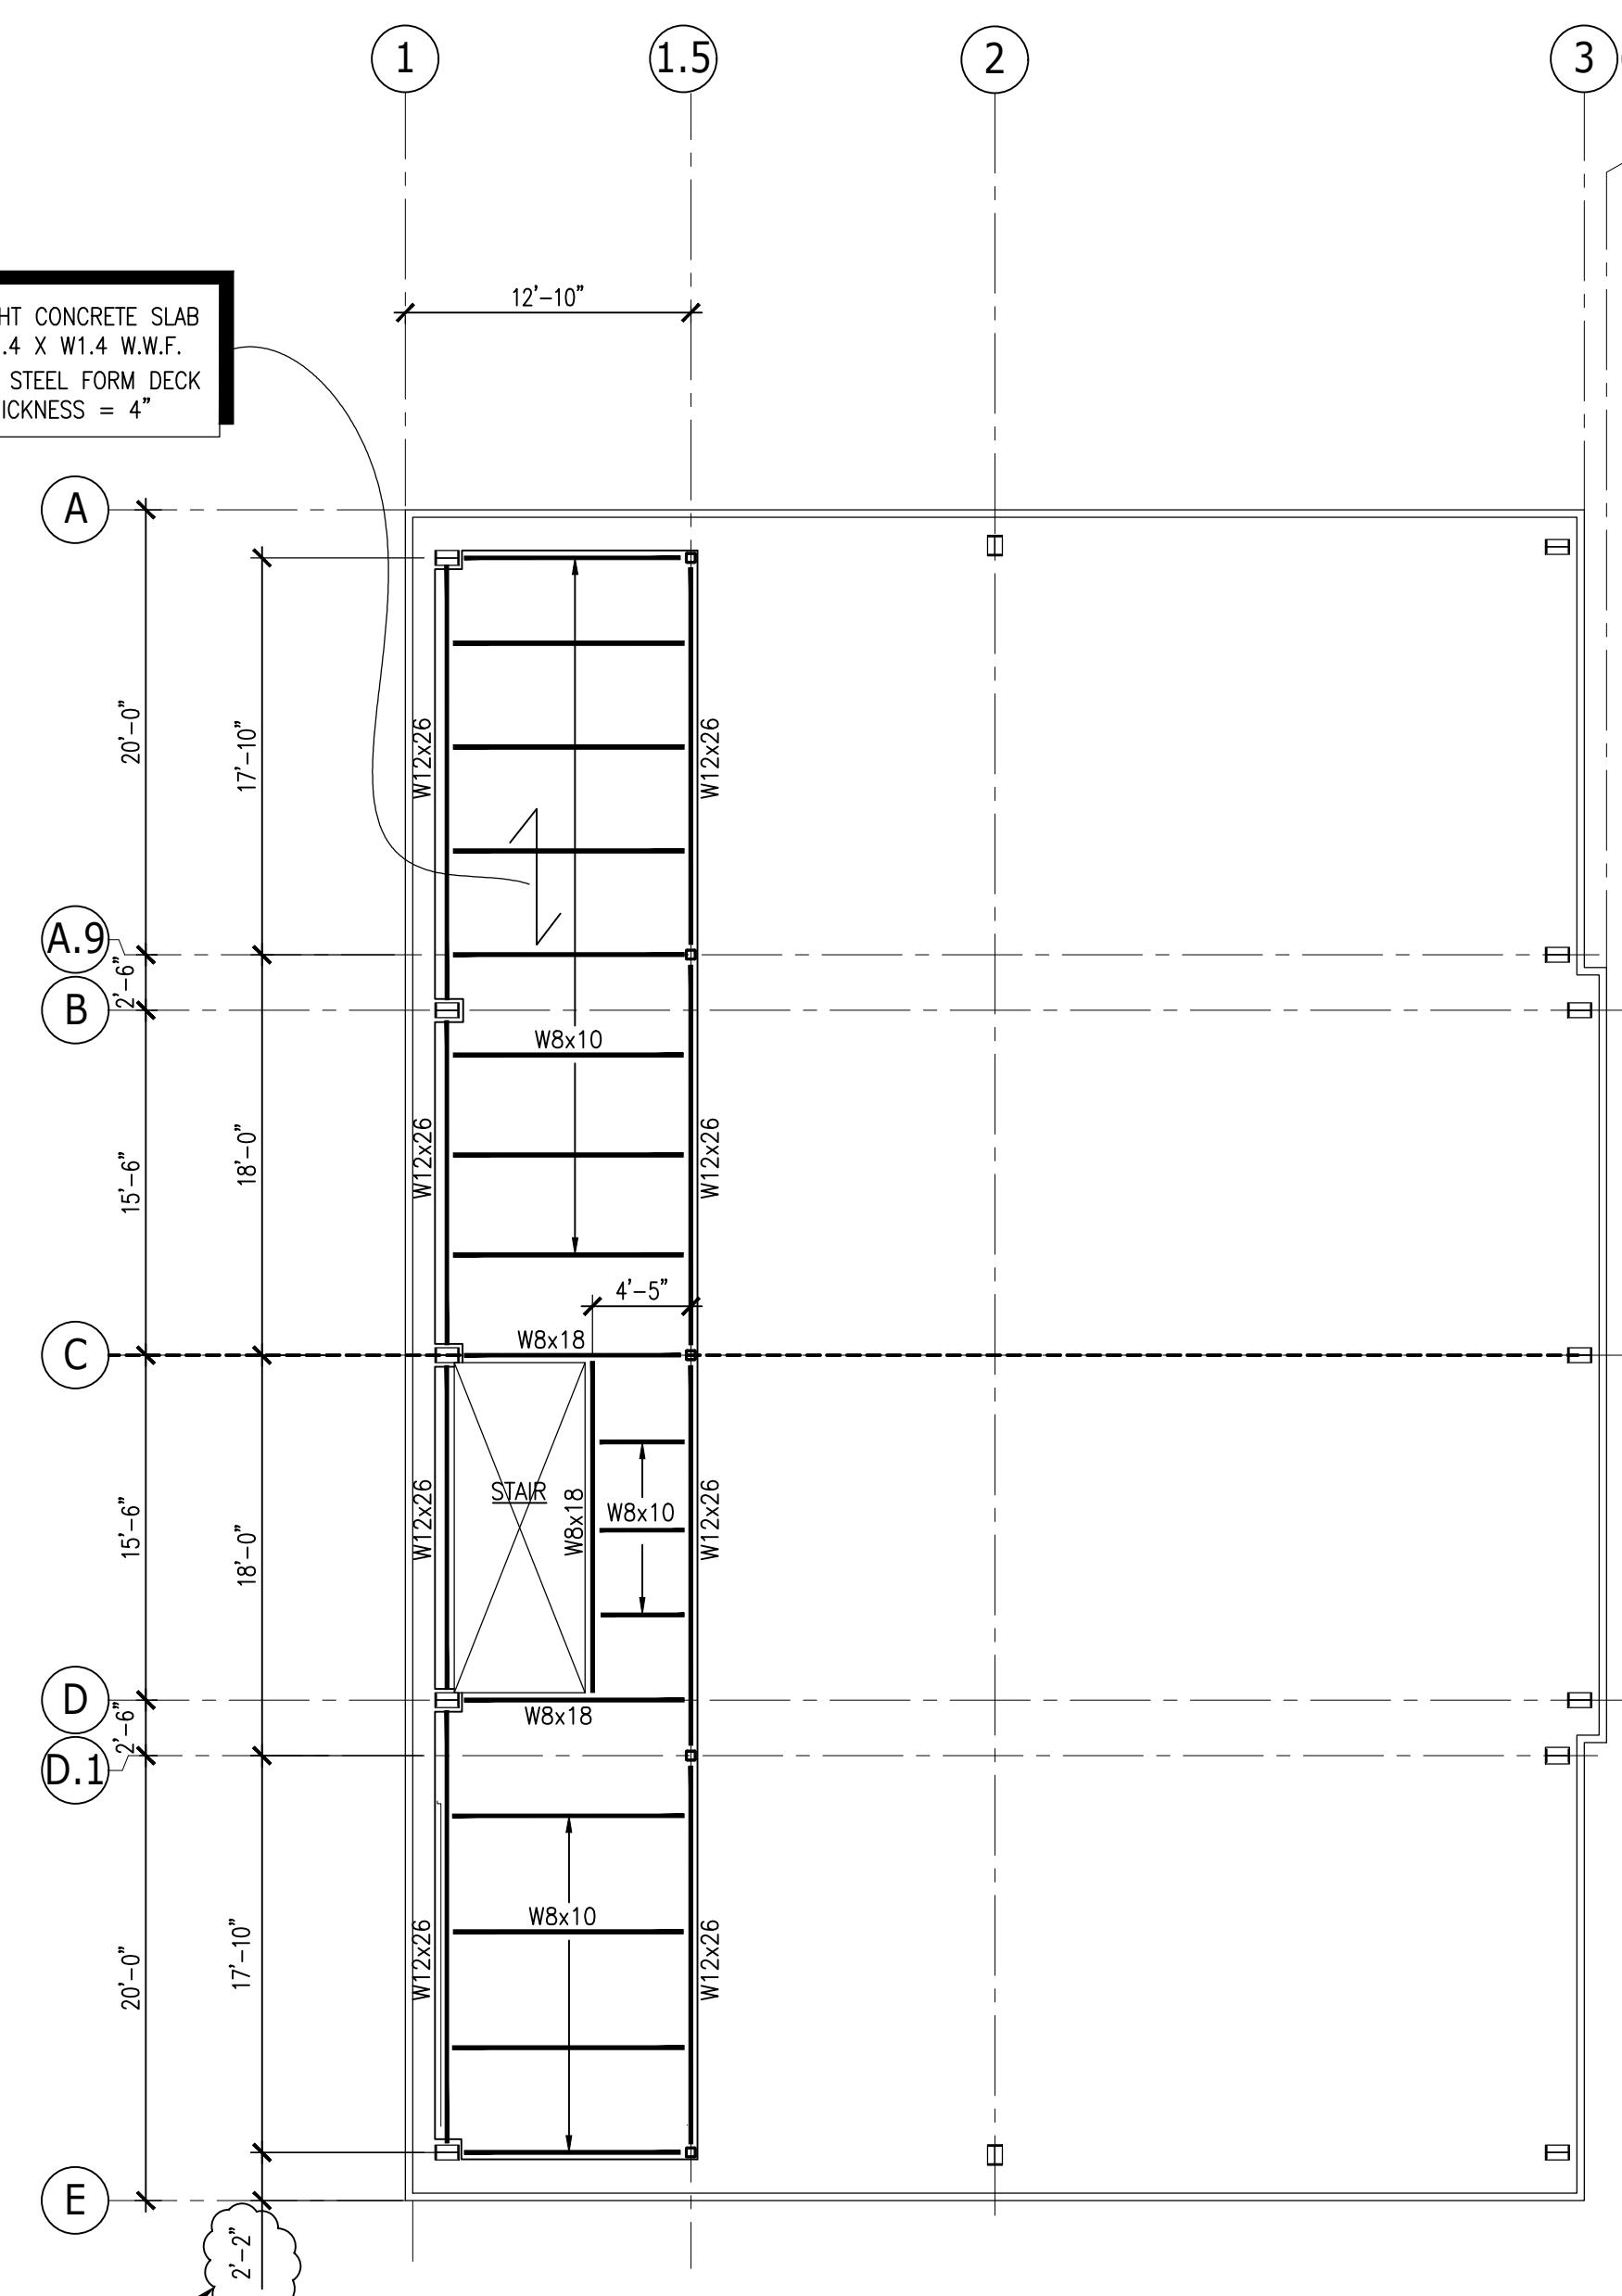
Drawn by AJG  
Checked by JRM  
Revised on 9/27/24

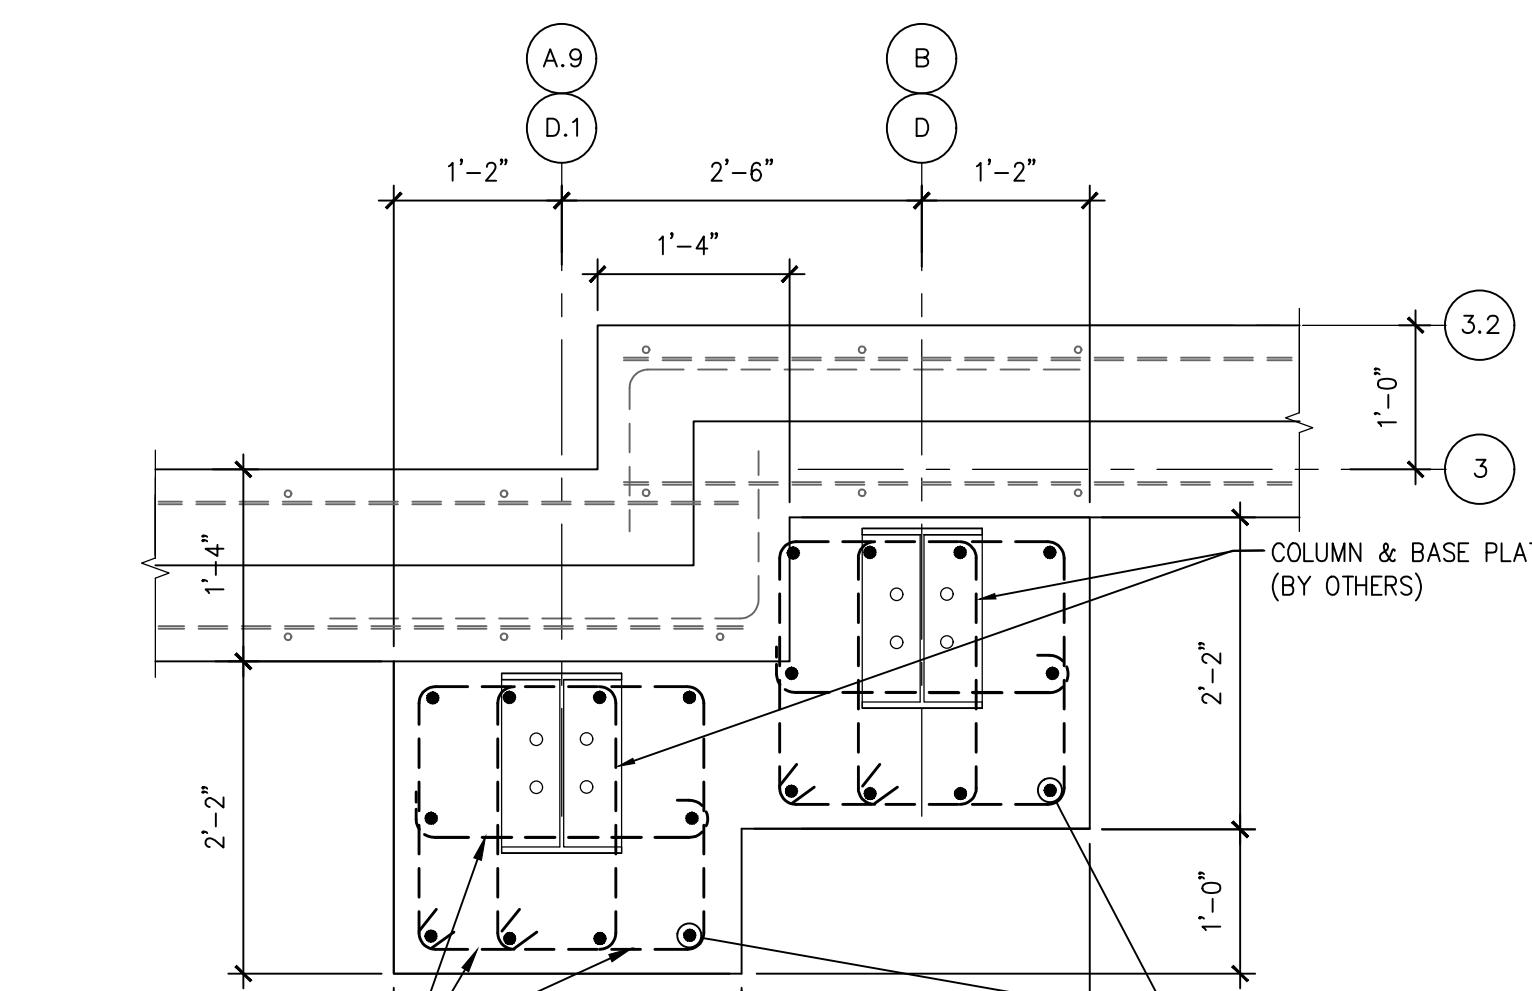△ ADDENDUM 4



FOUNDATION PLAN  
SCALE: 1/8"=1'-0"

NOTES:  
1. FINISH FLOOR CALLED ELEV.= 0'-0"  
2. ALL DIMENSIONS SHALL BE COORDINATED WITH ARCHITECT'S DRAWINGS  
3. FOUNDATION MUST BE CHECKED FOR LOADS PROVIDED BY METAL BUILDING MANUFACTURER  
BEFORE CONSTRUCTION BEGINS.  
[XX'-XX"] INDICATES TOP OF WALL AND SHELF ELEV.  
[XX'-XX"] INDICATES BOTTOM OF FOOTING ELEV.  
(S.J.) INDICATES SHRINKAGE CONTROL JOINT (SEE TYPICAL SLAB-ON-GRADE DETAIL)

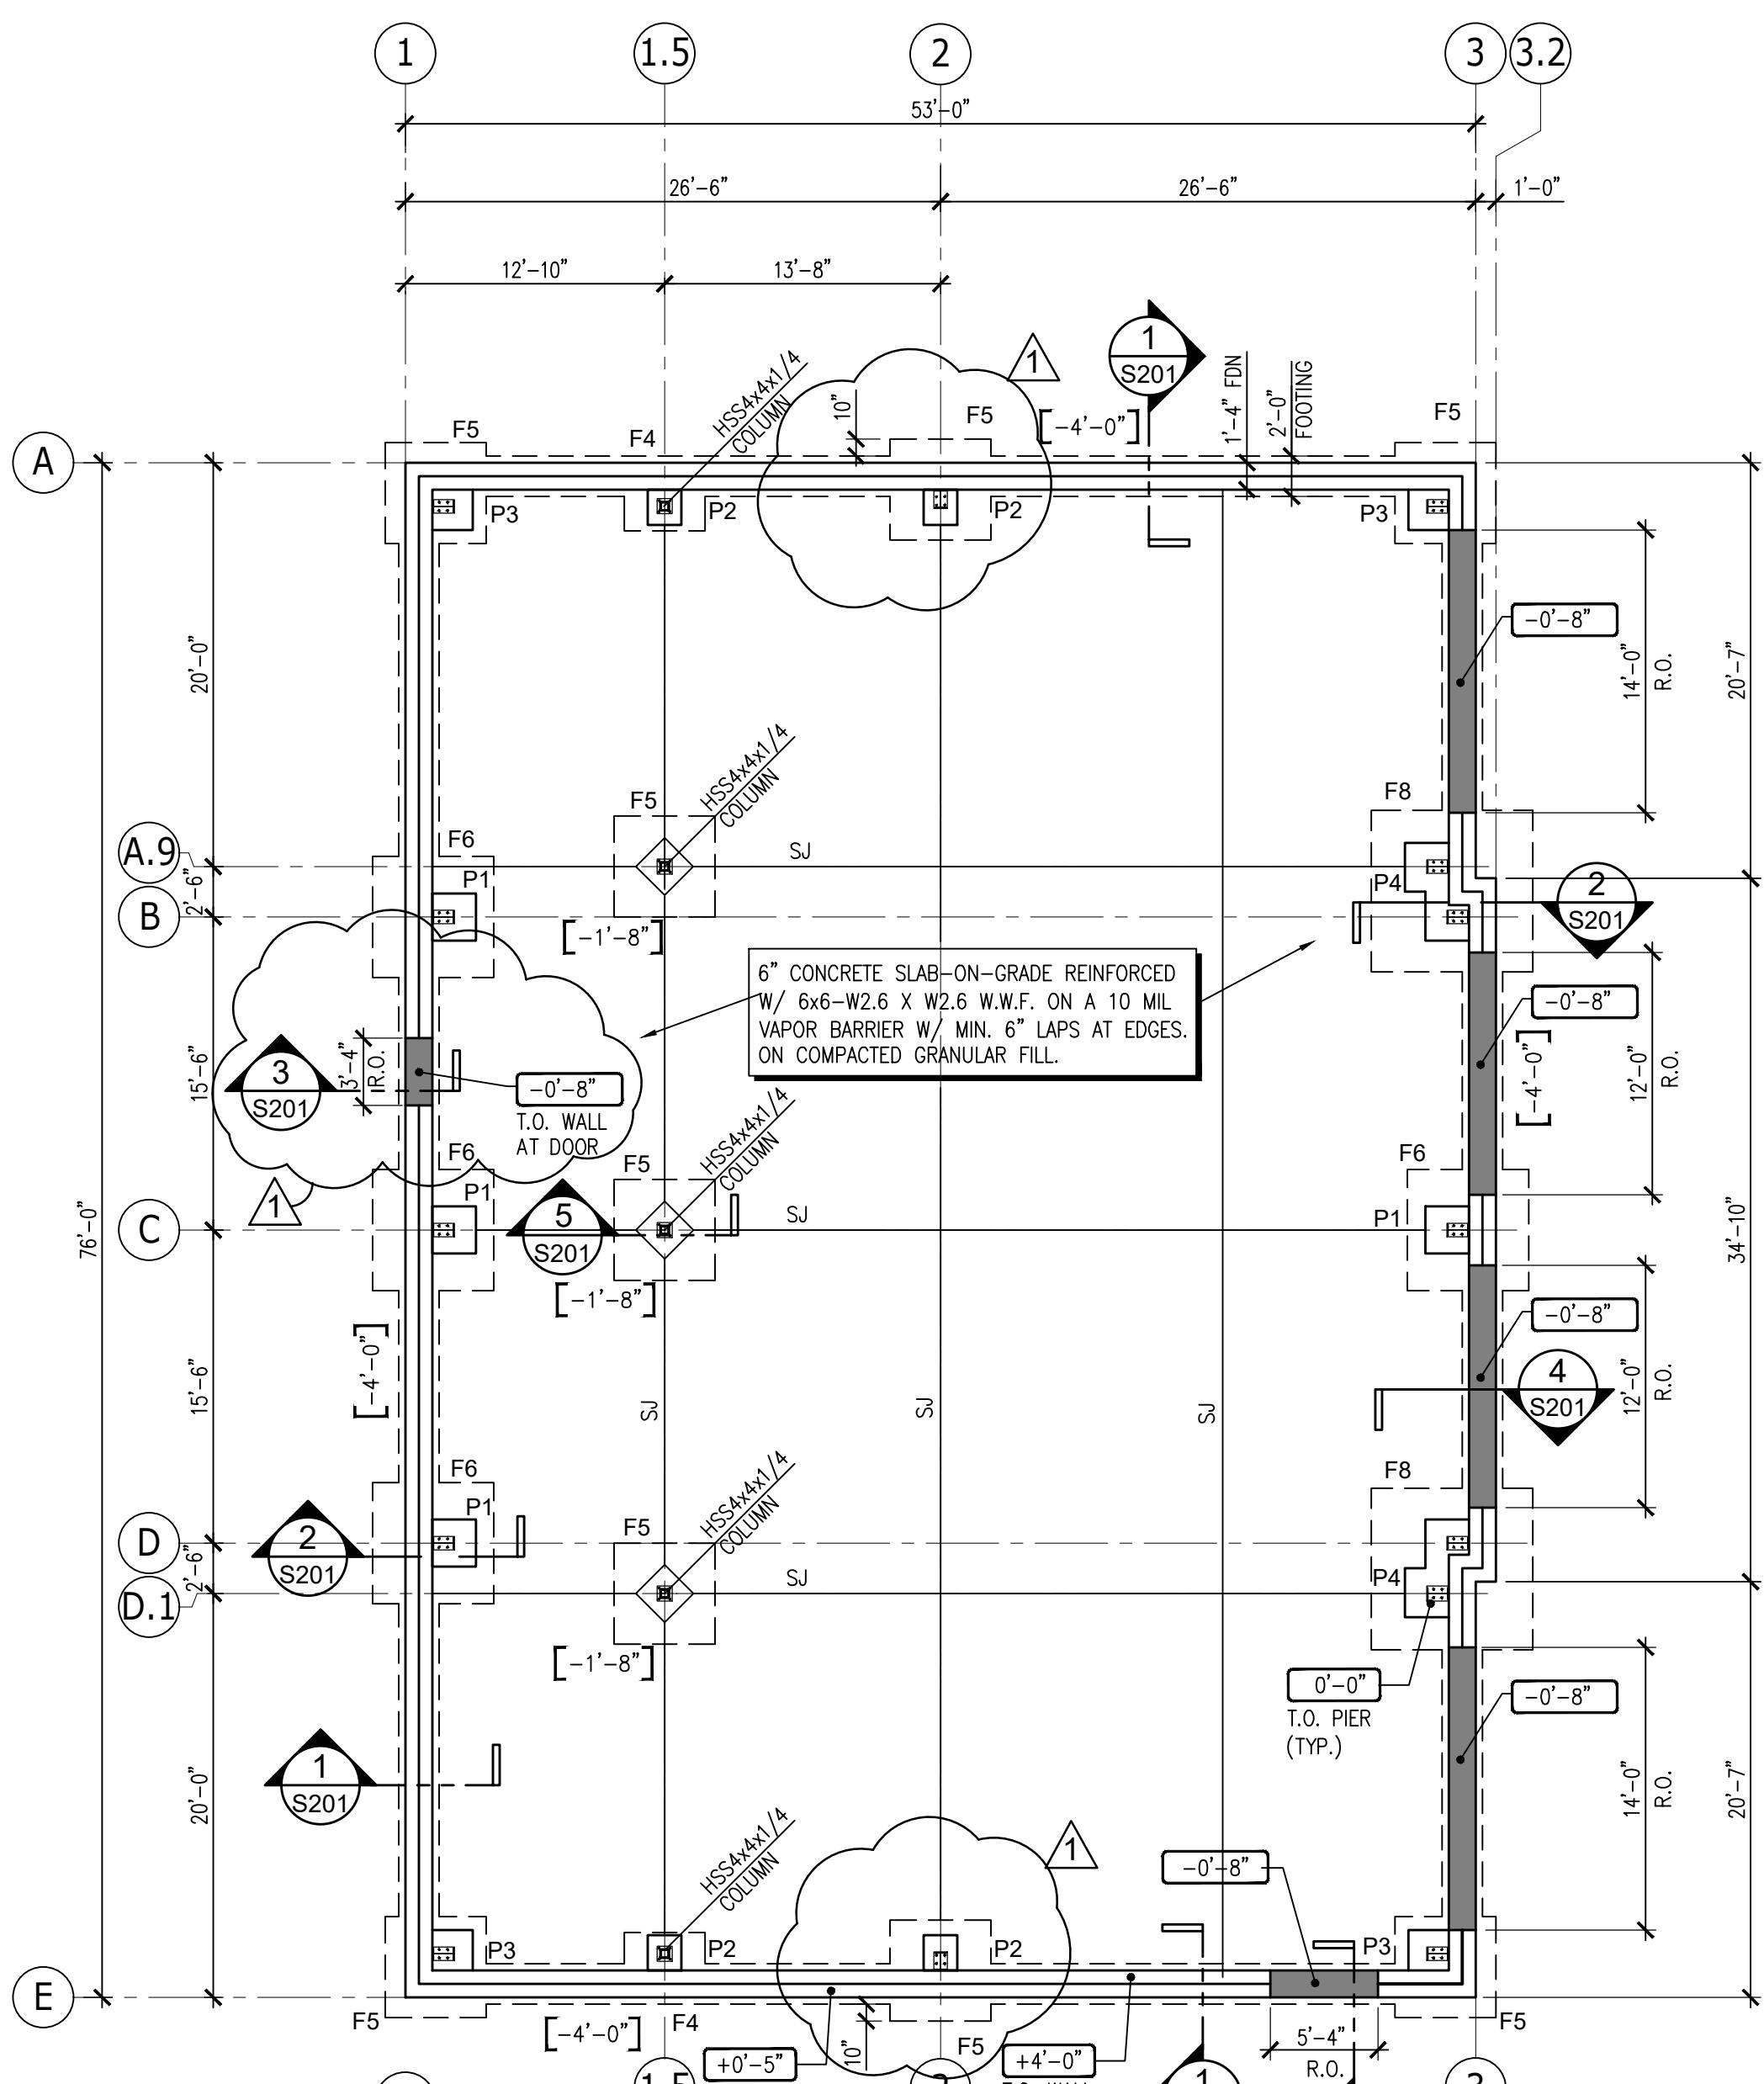

MEZZANINE LEVEL FRAMING PLAN  
SCALE: 1/8"=1'-0"

NOTES:  
1. MEZZANINE DESIGN LOADING:  
DL = 15 PSF  
SLAB = 43 PSF  
LL = 150 PSF  
2. PEMB COLUMNS ON GRID LINE 1  
SHALL BE DESIGNED TO SUPPORT  
MEZZANINE FRAMING

Consultant:  
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100% CONSTRUCTION  
DOCUMENTS

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Sheet Contents


FOUNDATION PLAN  
AND MEZZANINE LEVEL  
FRAMING PLAN

Project Number. 6790


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S101


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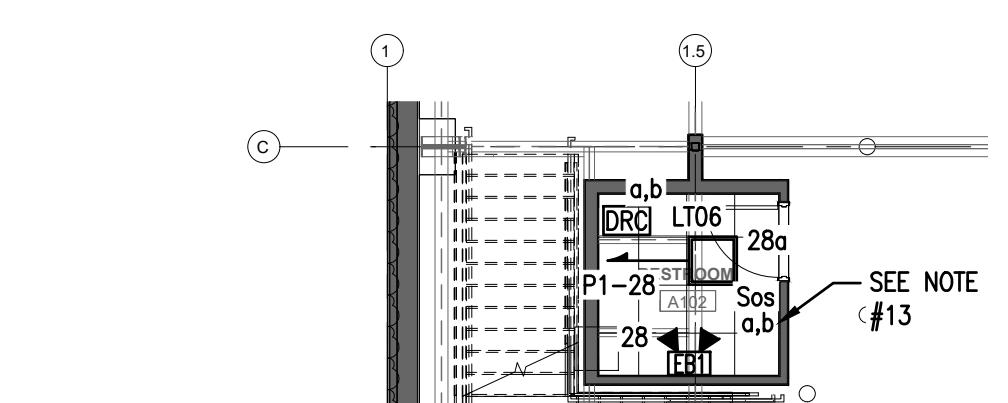
1 FIRST FLOOR LIGHTING PLAN

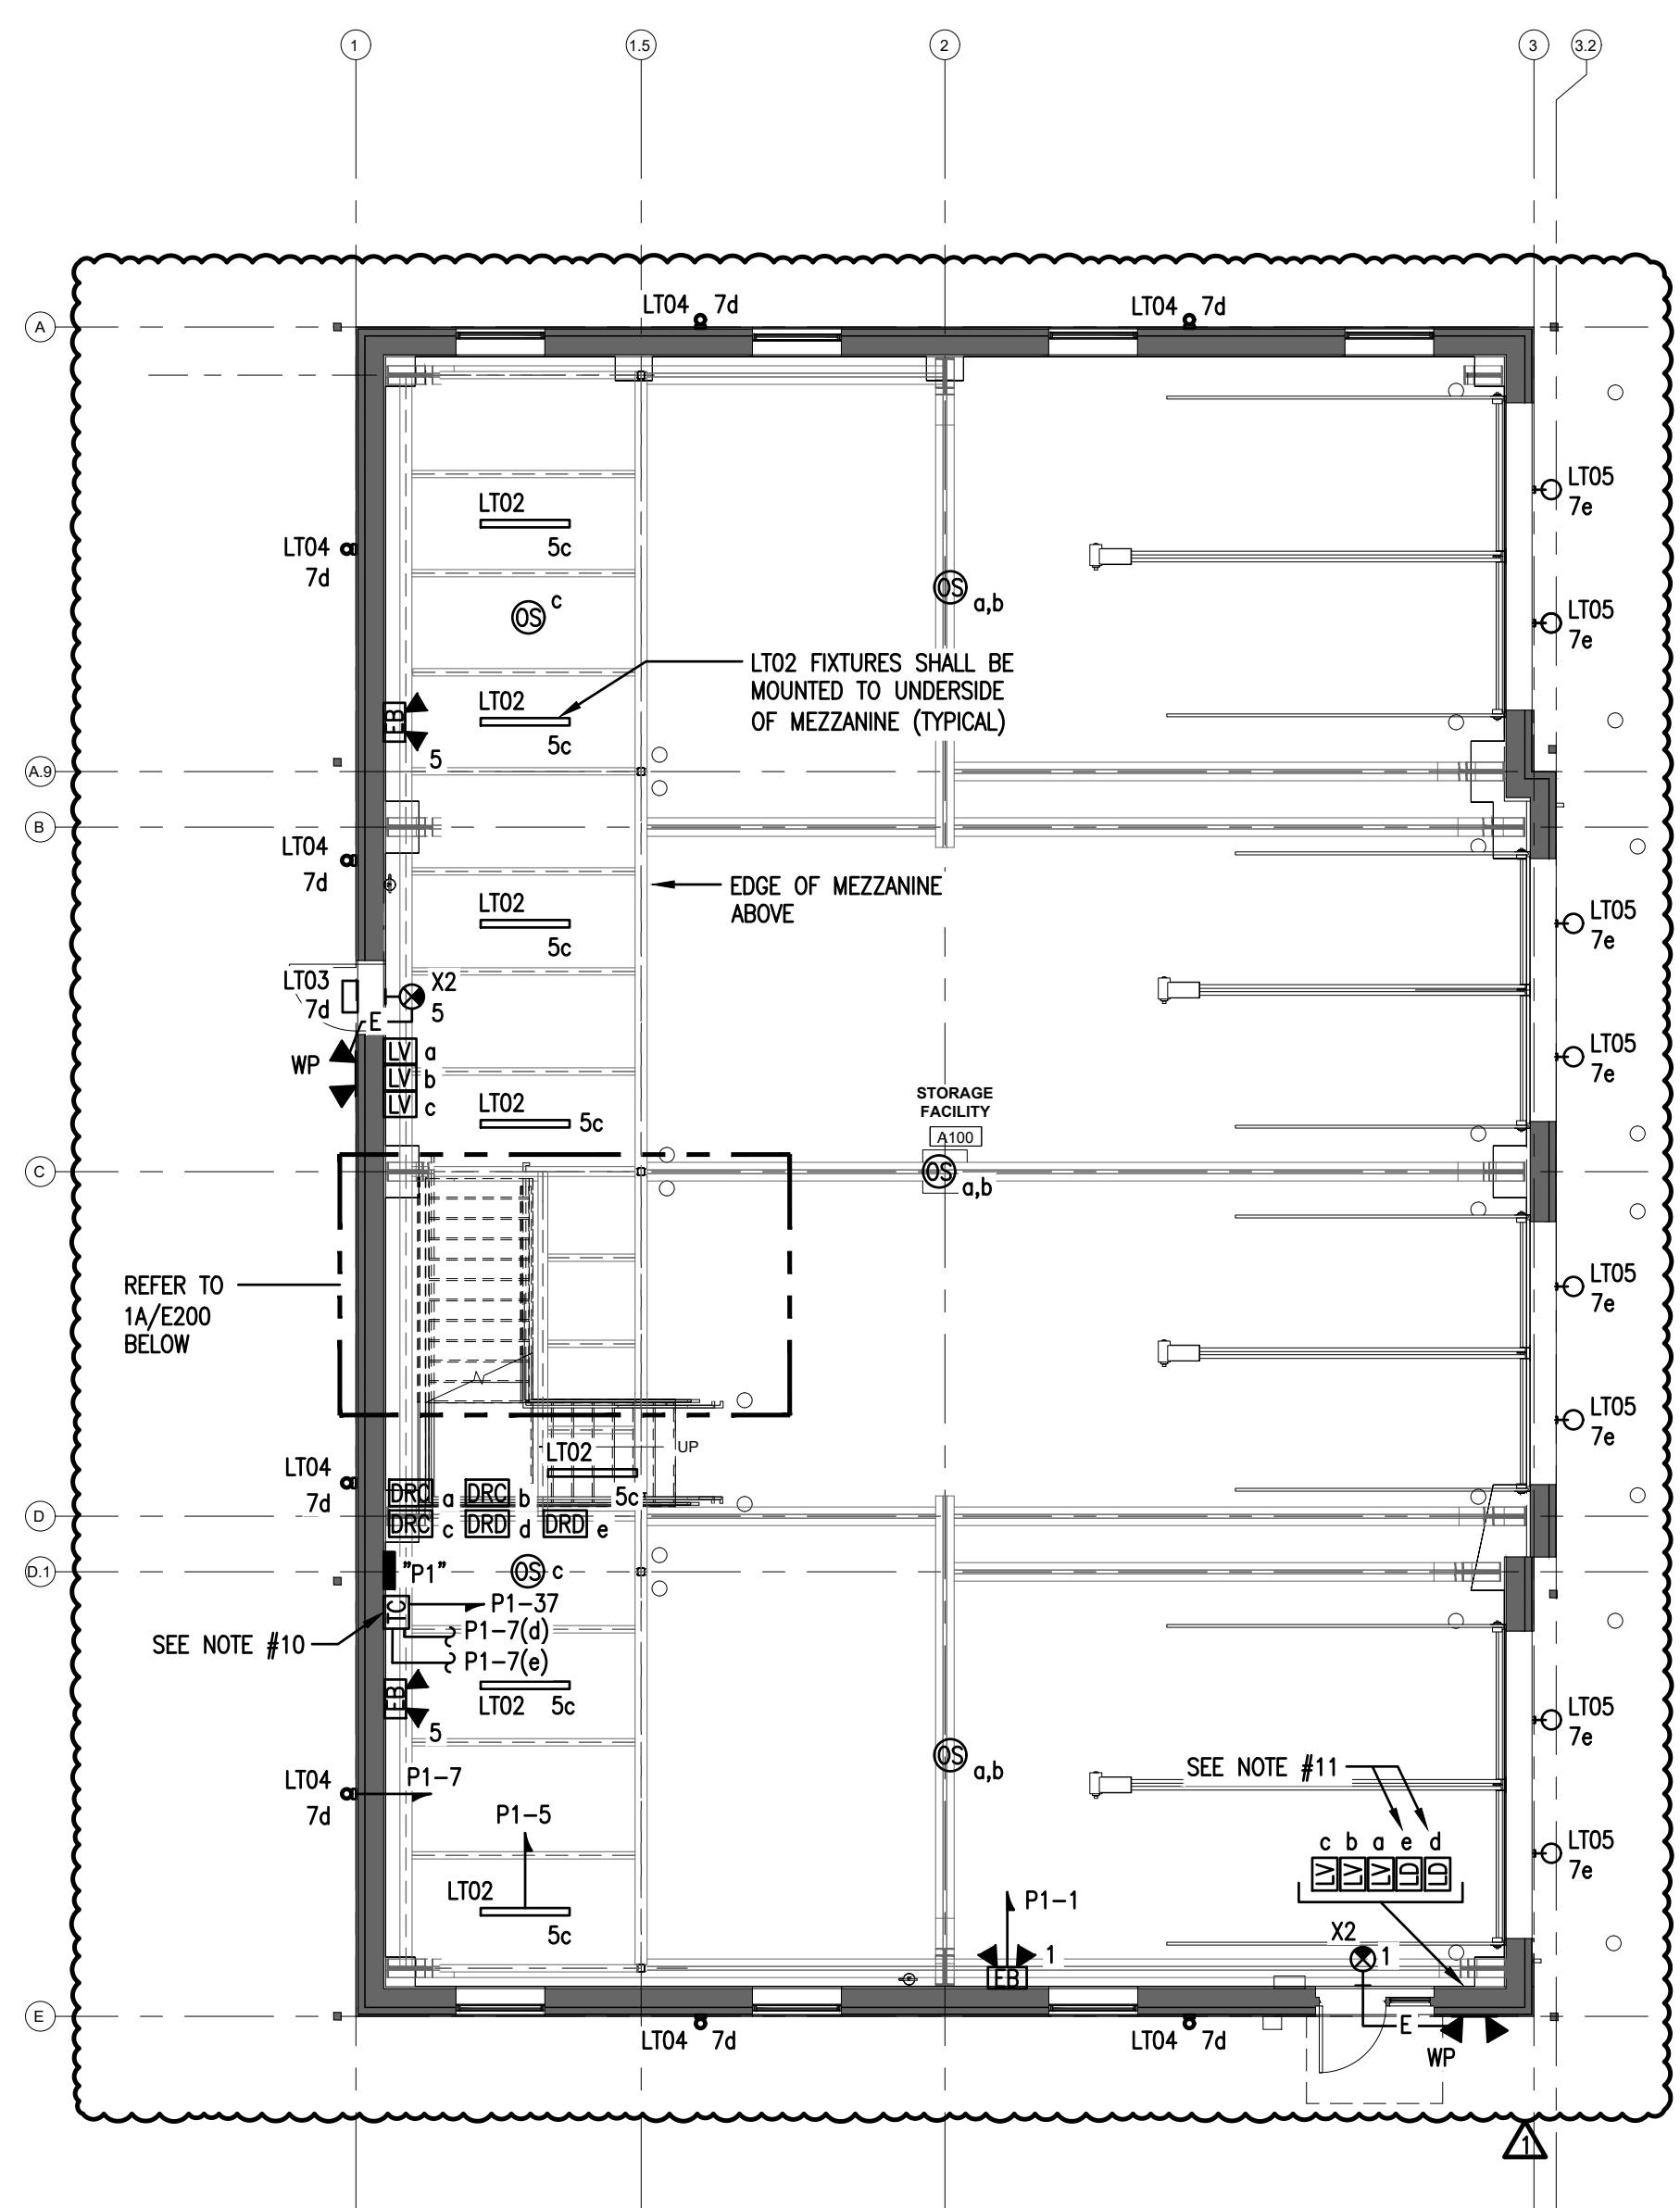


2 FIRST FLOOR POWER PLAN

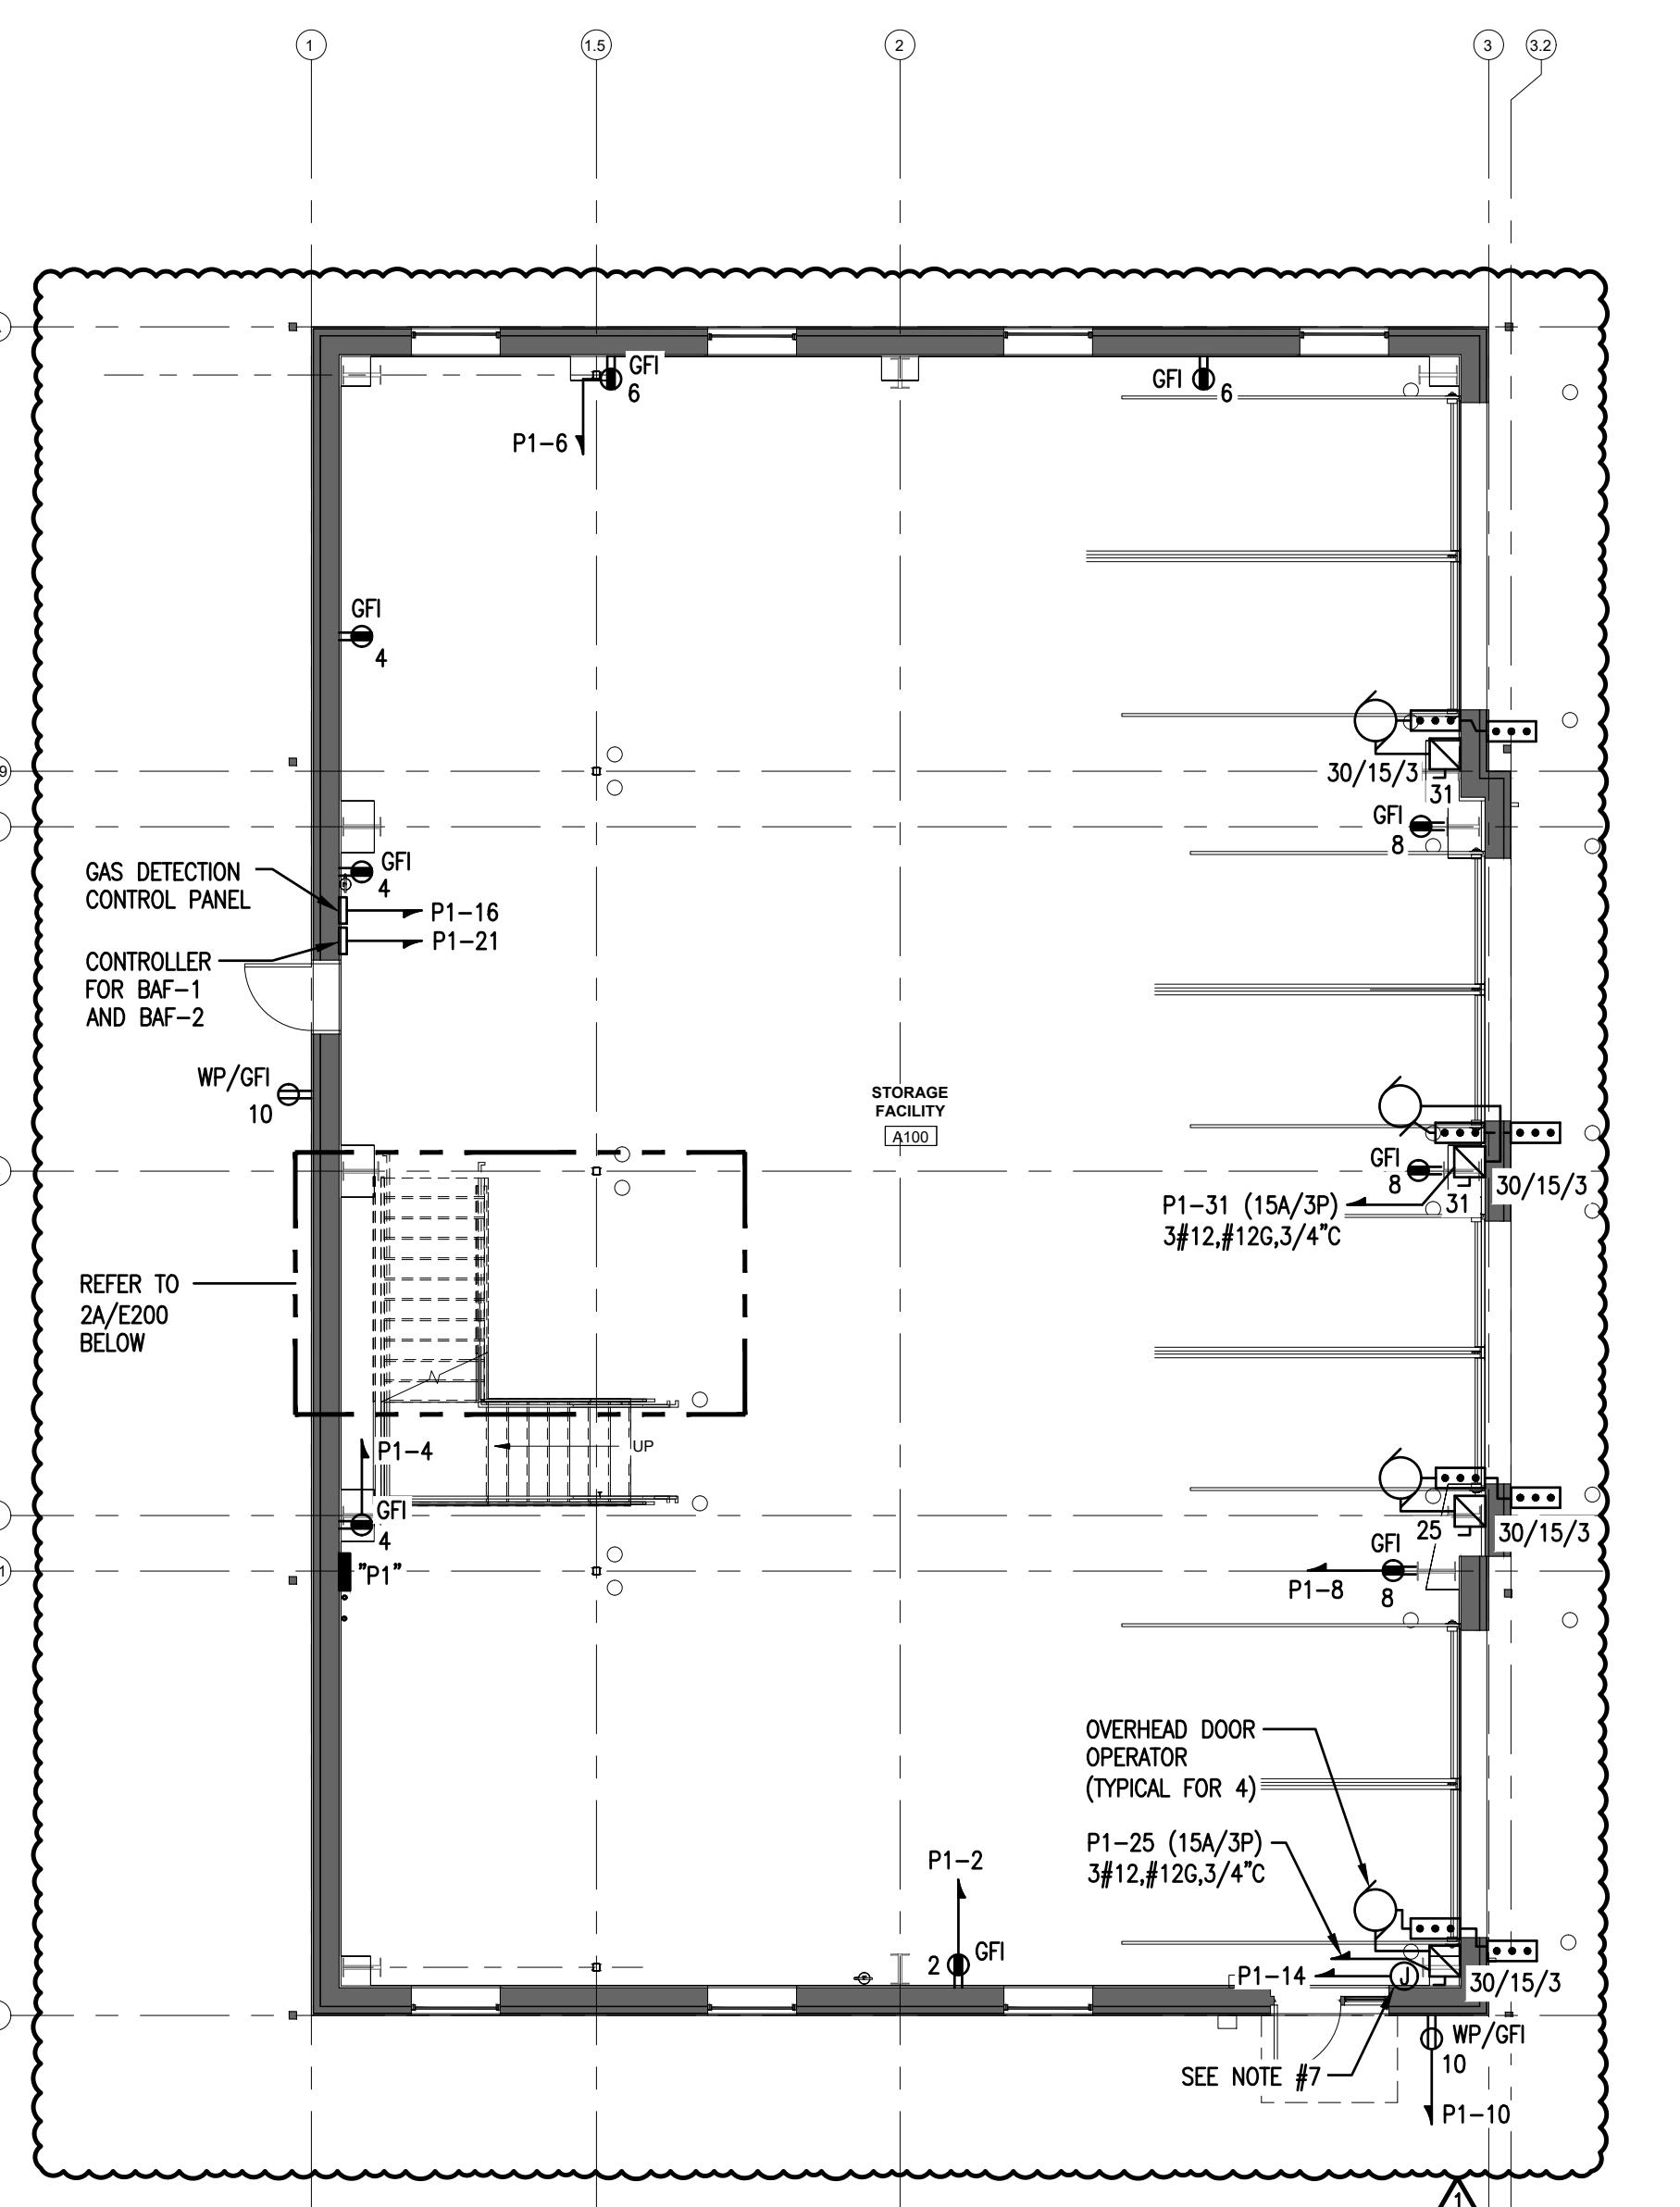

3 MEZZANINE LIGHTING & POWER PLAN

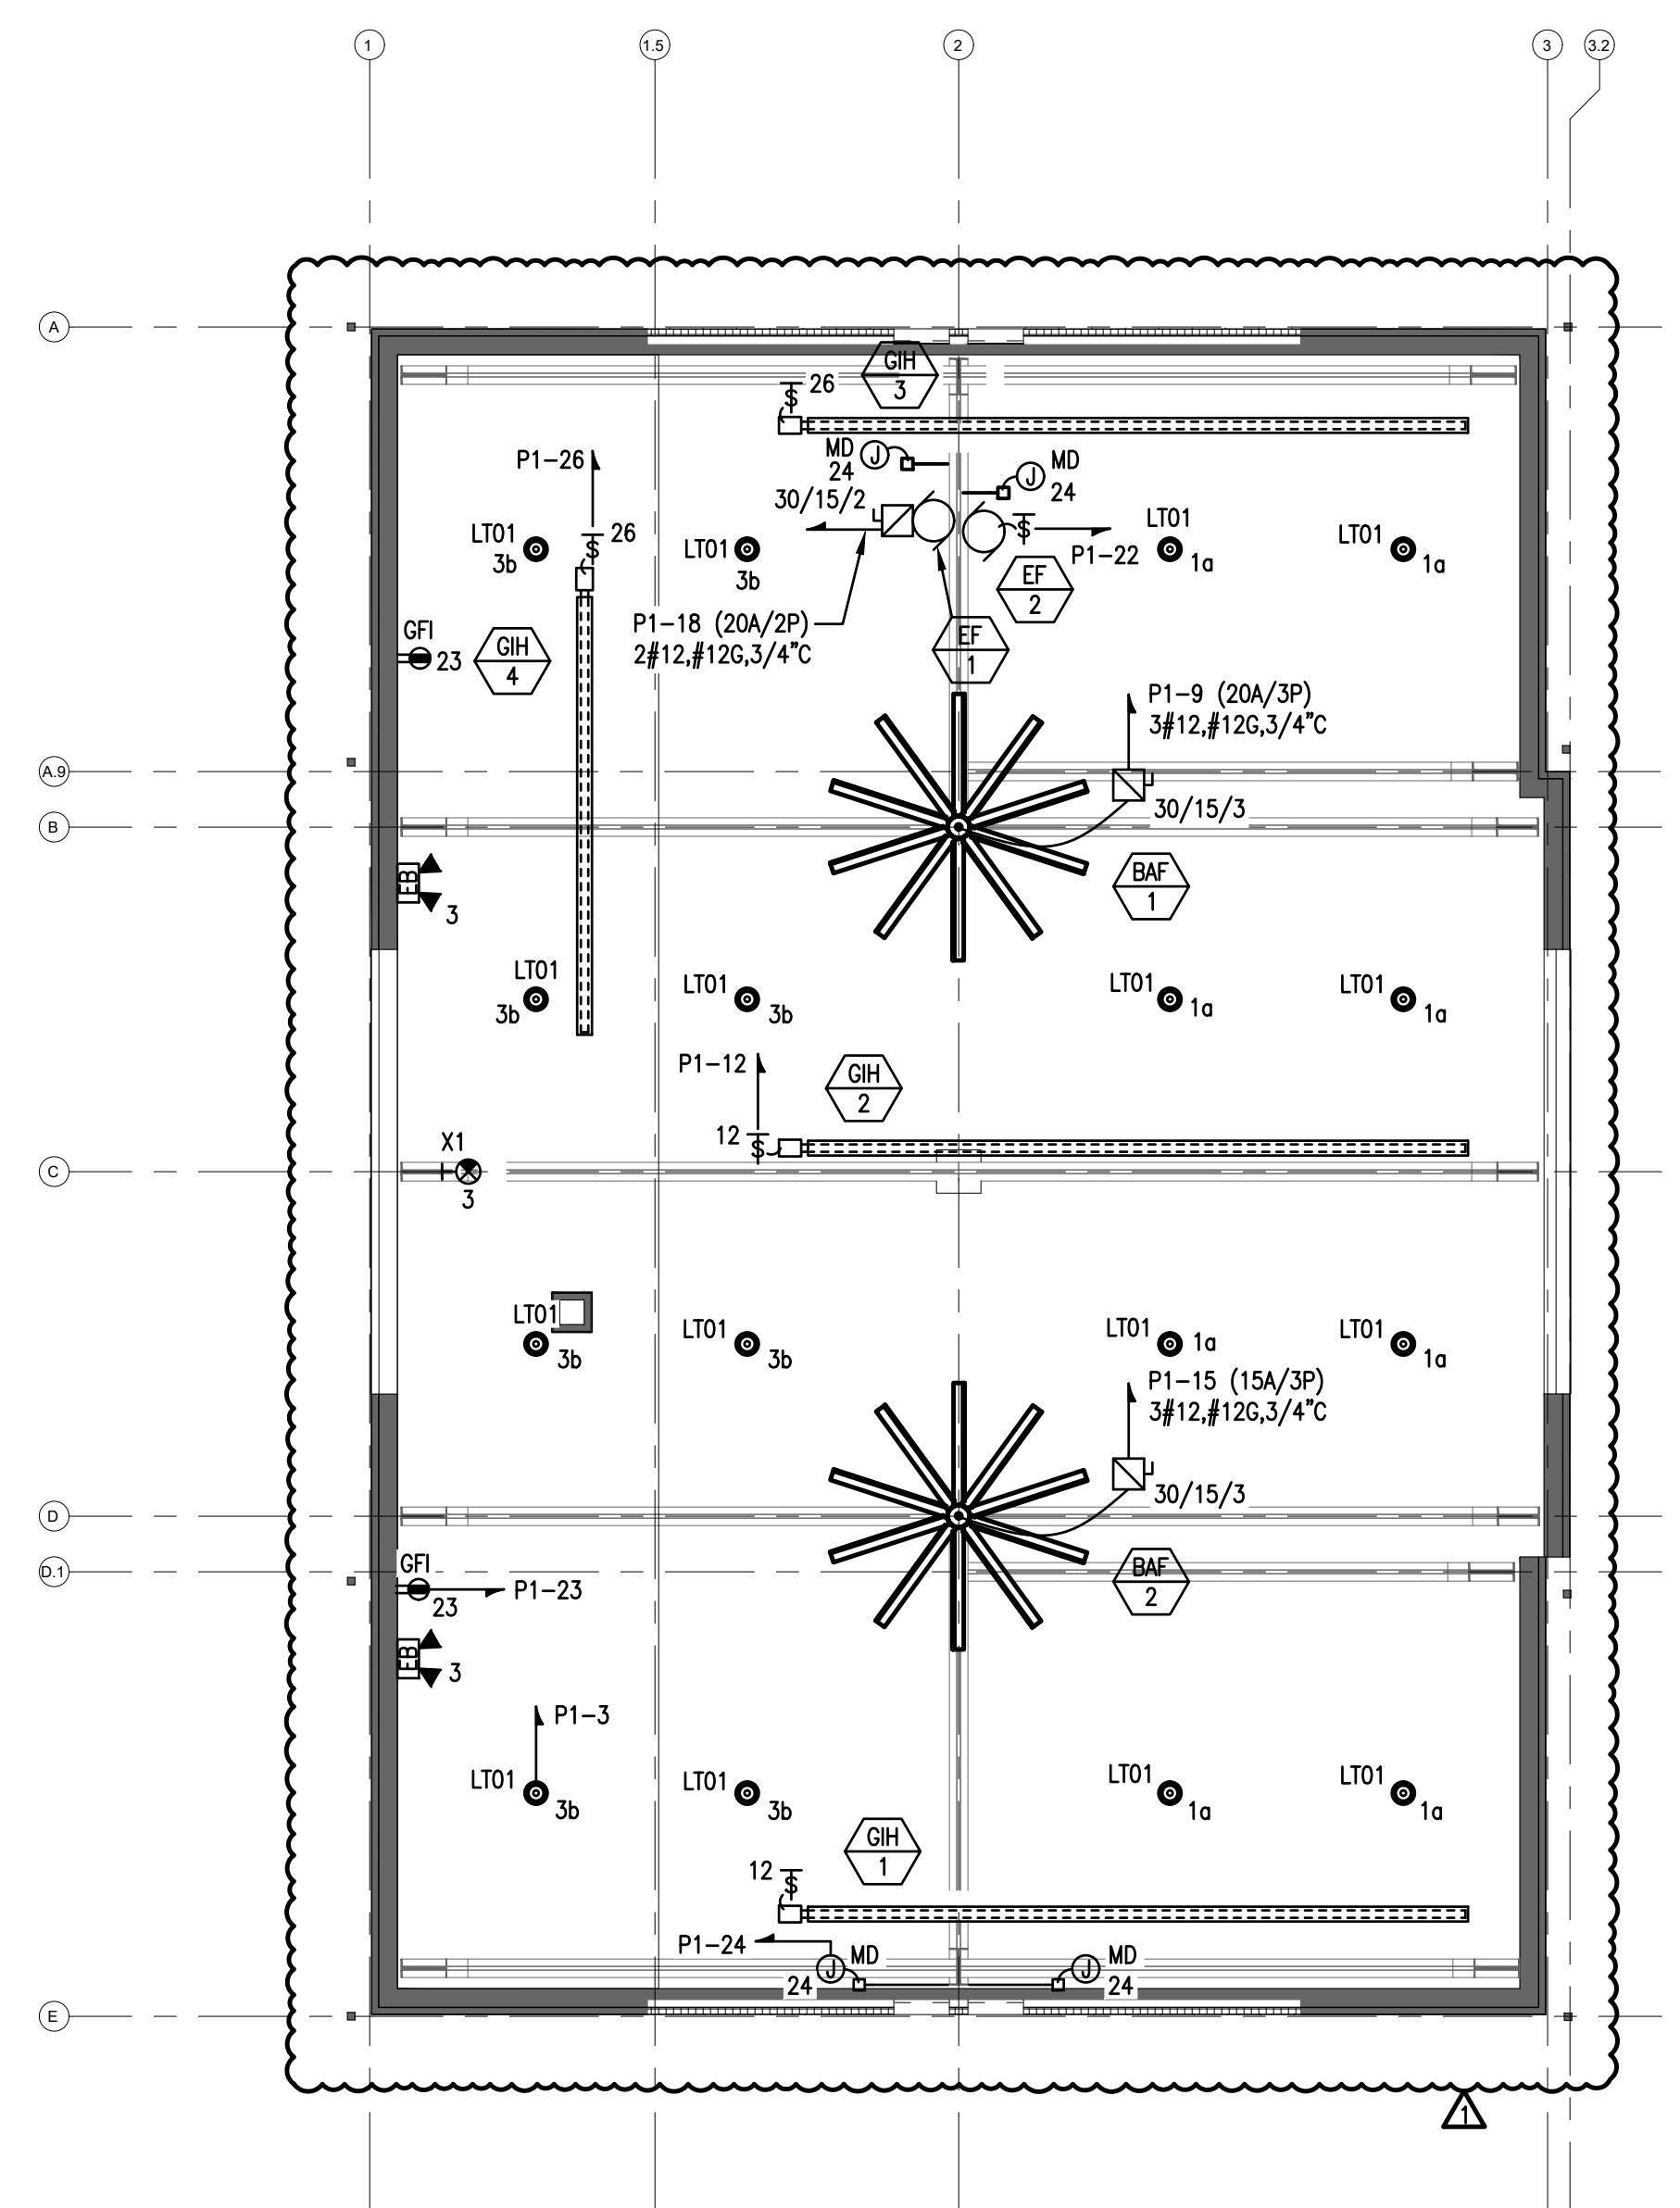


1A FIRST FLOOR LIGHTING PLAN

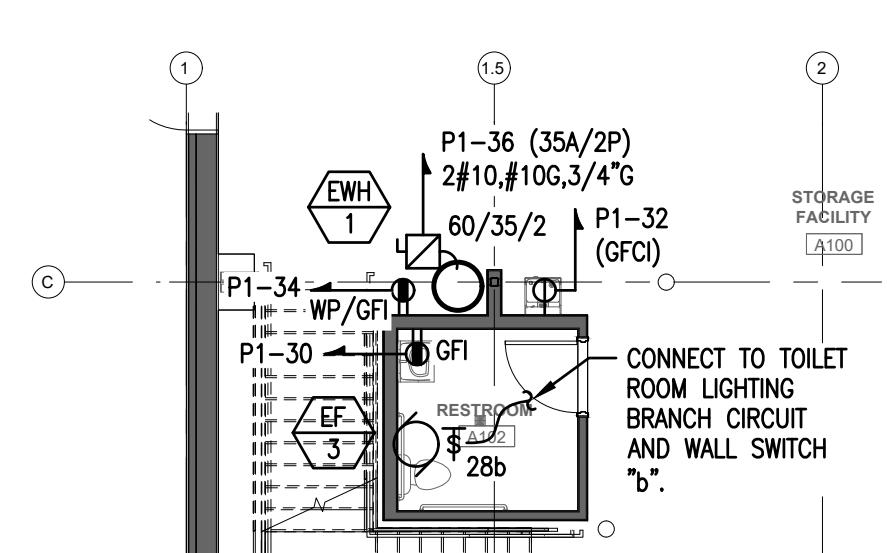

2A FIRST FLOOR POWER PLAN

**ELECTRICAL NOTES**


1. RECEPTACLES AND WALL SWITCHES LOCATED WITHIN THE GARAGE AND AT THE MEZZANINE SHALL BE SURFACE MOUNTED AND LOCATED AT 44" AFF UNLESS NOTED OTHERWISE. ALL RECEPTACLES SHALL BE GFCI TYPE. PROVIDE METAL OUTLET BOXES WITH STAINLESS STEEL FACEPLATES. WIRING SHALL BE PROVIDED IN EMT CONDUIT.
2. WALL AND CEILING MOUNTED ELECTRICAL DEVICES, FIXTURES, AND EQUIPMENT WITHIN THE BUILDING SHALL BE SURFACE MOUNTED. WIRING SHALL BE PROVIDED IN EMT CONDUIT. ALL OUTLET AND JUNCTION BOXES SHALL BE METAL WITH STAINLESS STEEL COVERS/FACEPLATES.
3. EXIT SIGNS AND EMERGENCY LIGHTING UNITS SHALL BE WIRED AHEAD OF LIGHTING CONTROLS.
4. ELECTRICAL SUB-CONTRACTOR SHALL BE RESPONSIBLE FOR PROVIDING ALL WIRING ASSOCIATED WITH OVERHEAD DOOR MOTORS/OPERATORS, AND ALL ASSOCIATED ACCESSORIES. ALL WIRING SHALL BE PROVIDED PER MANUFACTURER'S INSTALLATION INSTRUCTIONS.
5. CEILING FANS BAF-1 AND BAF-2 ARE EACH PROVIDED WITH A VFD BY THE MECHANICAL SUB-CONTRACTOR. THE ELECTRICAL SUB-CONTRACTOR SHALL BE RESPONSIBLE FOR THE INSTALLATION AND WIRING OF THE VFD'S AND PROVIDING CAT 5 WIRING FROM EACH VFD TO THE CONTROLLER. THE CONTROLLER SHALL BE FURNISHED AND INSTALLED BY THE MECHANICAL SUB-CONTRACTOR, WIRED BY THE ELECTRICAL SUB-CONTRACTOR. ALL WIRING SHALL BE PROVIDED PER MANUFACTURER'S INSTALLATION INSTRUCTIONS.
6. GAS DETECTION SYSTEM CONTROL PANEL AND SENSORS SHALL BE PROVIDED AND INSTALLED BY THE MECHANICAL SUB-CONTRACTOR, WIRED BY THE ELECTRICAL SUB-CONTRACTOR. ALL WIRING SHALL BE PROVIDED PER MANUFACTURER'S INSTALLATION INSTRUCTIONS.
7. PROVIDE CONNECTION TO ELECTRONIC TRAP PRIMER. COORDINATE EXACT REQUIREMENTS AND LOCATION WITH PLUMBING CONTRACTOR.
8. CONCRETE STRUCTURAL STEM WALL AT PERIMETER OF BUILDING EXTENDS TO 48" AFF. PROVIDE SUPPORT FRAME WITH PLYWOOD BACKBOARD AS REQUIRED FOR INSTALLATION OF PANELBOARD "P1".
9. LIGHTING CONTROL OCCUPANCY SENSORS SHALL BE MOUNTED TO BOTTOM OF STRUCTURAL STEEL.
10. PROVIDE 2-CIRCUIT ELECTRONIC TIME CLOCK FOR CONTROL OF EXTERIOR LIGHTING BRANCH CIRCUIT P1-7. (REFER TO DRAWING E100 FOR MODEL. TIMECLOCK CIRCUIT #1 SHALL CONTROL SIDE AND REAR SCONCES "LT03" AND "LT04" ON DIMMING SWITCH "a". TIMECLOCK CIRCUIT #2 SHALL CONTROL FRONT SCONCES "LT05" ON DIMMING SWITCH "b". PROVIDE LABEL ON ENCLOSURE COVER INDICATING "EXTERIOR LIGHTS".
11. PROVIDE DIMMING WALL SWITCHES FOR CONTROL OF EXTERIOR WALL SCONCES. PROVIDE LABEL ON FACEPLATE OF EACH SWITCH TO INDICATE "SIDE/REAR LIGHTS" AND "FRONT LIGHTS".
12. OMITTED.
13. SWITCHES "a" (LIGHT) AND "b" (FF-3) SHALL BE PROGRAMMED FOR AUTO ON/AUTO OFF.

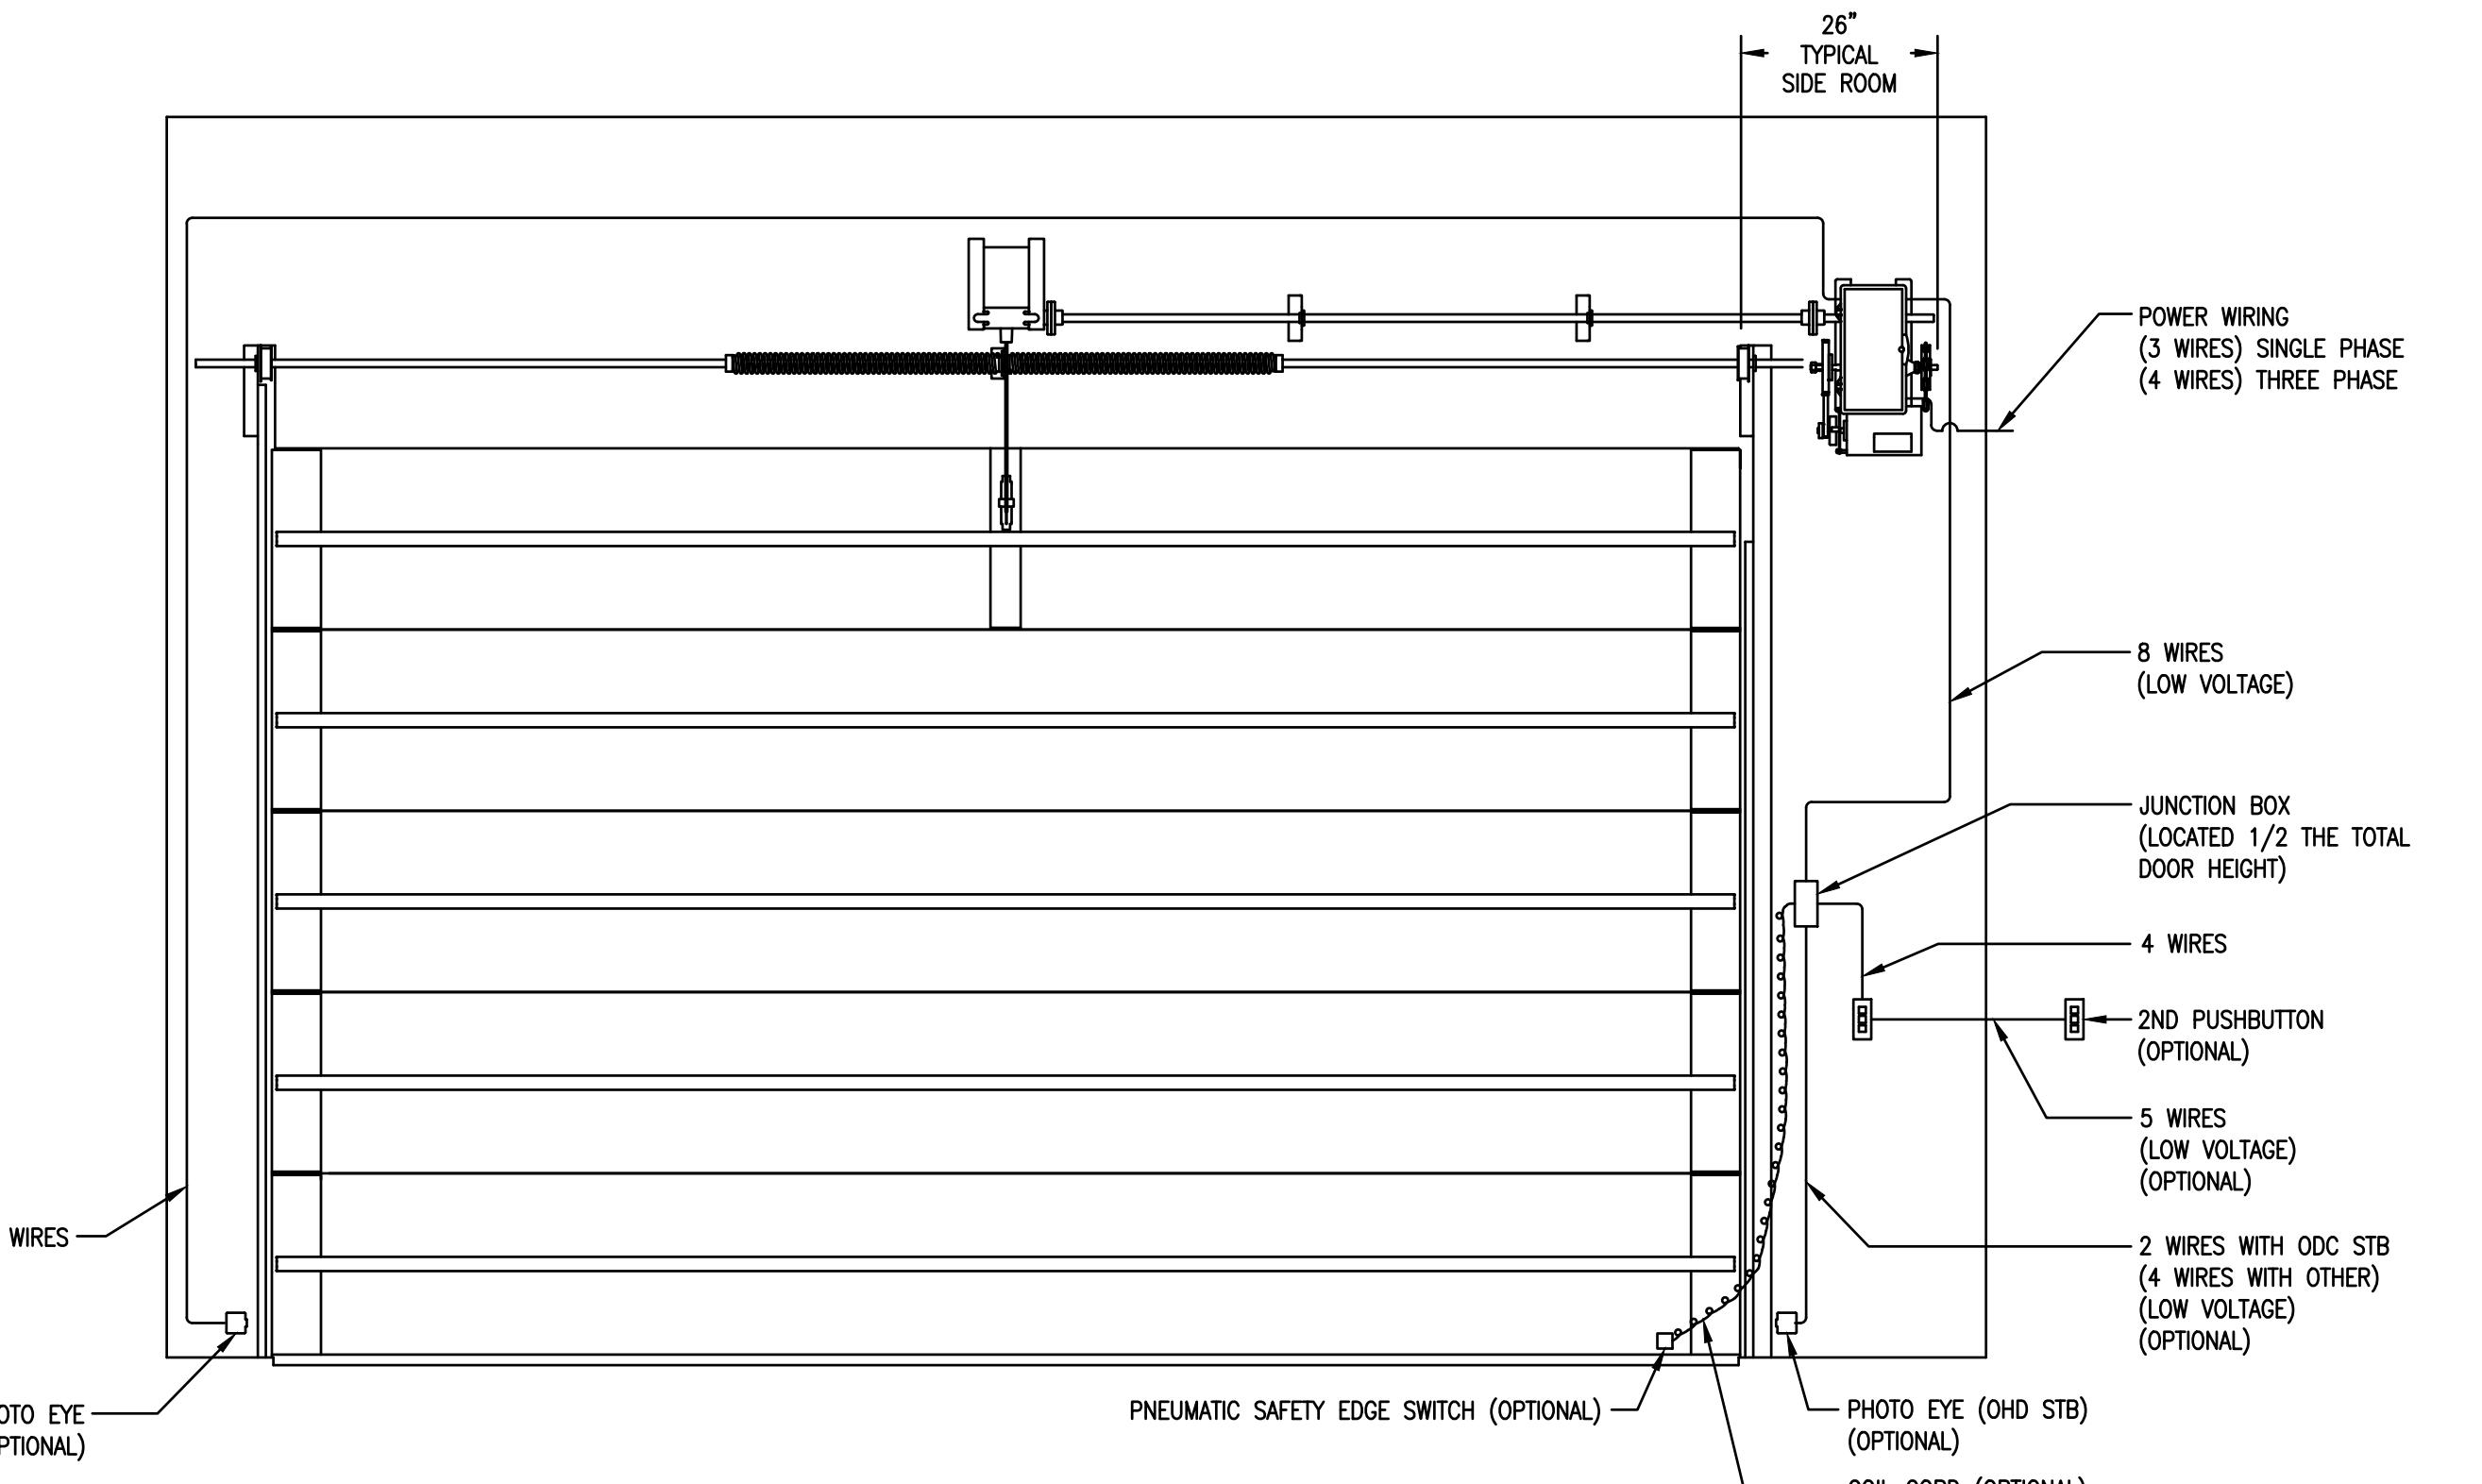

4 TYPICAL OVERHEAD DOOR WIRING DIAGRAM




**TYPICAL OVERHEAD DOOR WIRING DIAGRAM NOTES**

1. DETAIL SHOWN FOR GENERAL INFORMATION ONLY. OVERHEAD DOOR OPERATOR AND CONTROLS SHALL BE PROVIDED PER MANUFACTURER'S SPECIFICATIONS AND INSTALLATION INSTRUCTIONS.

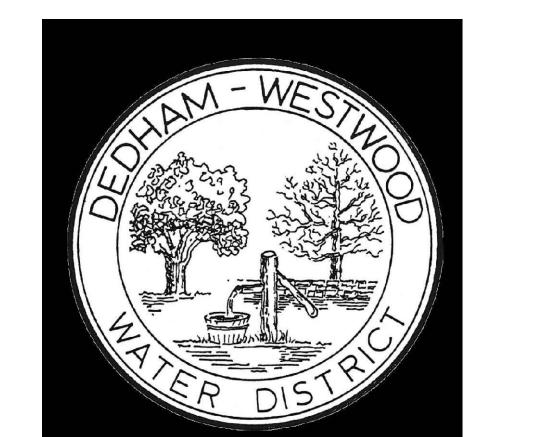


## 4' X 5' CANTILEVER CANOPY (WHITE)

QTY: 2

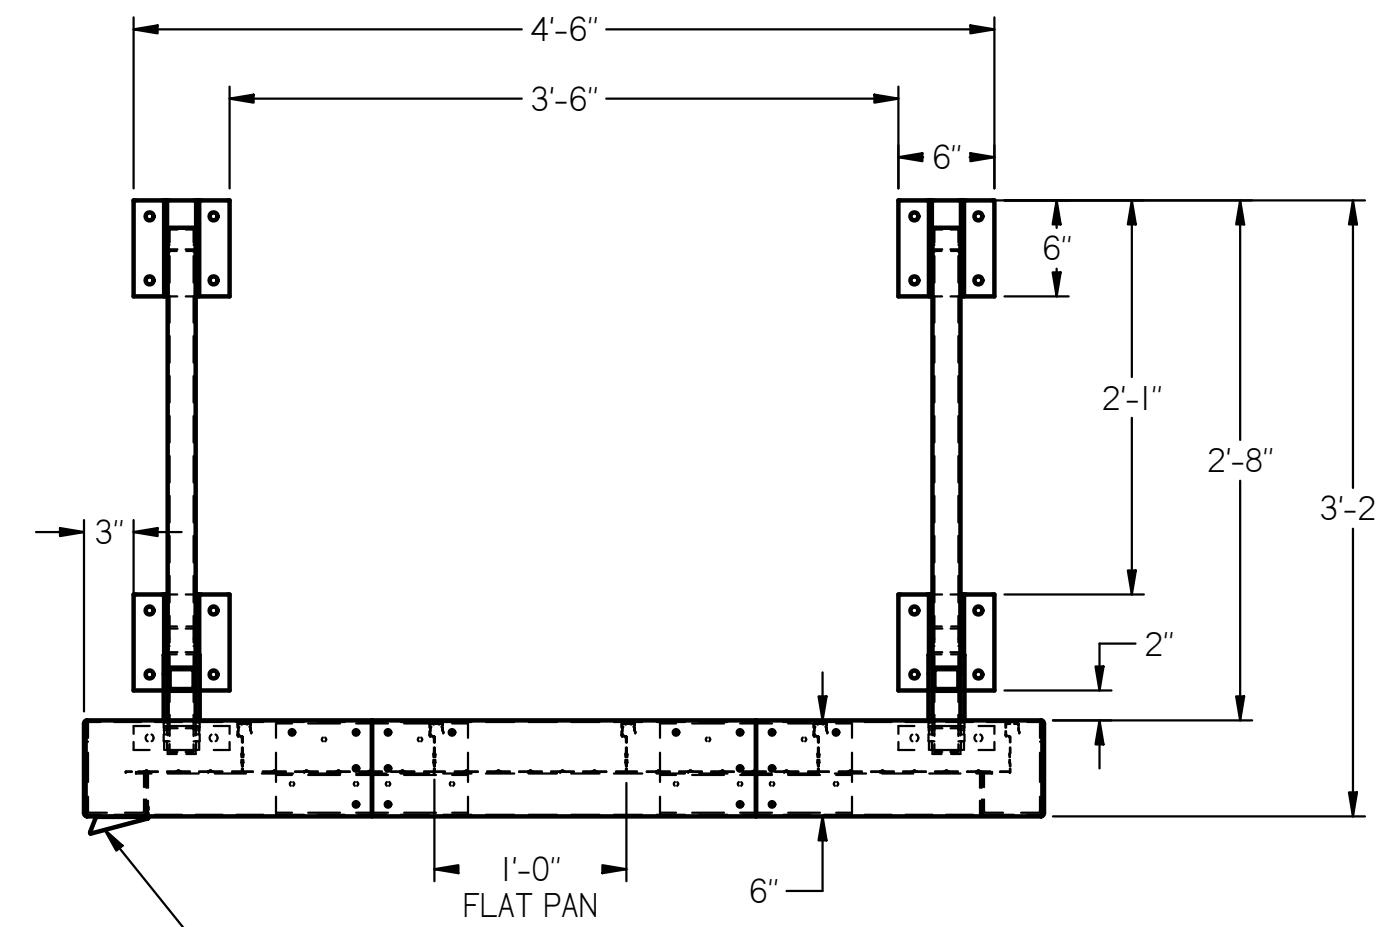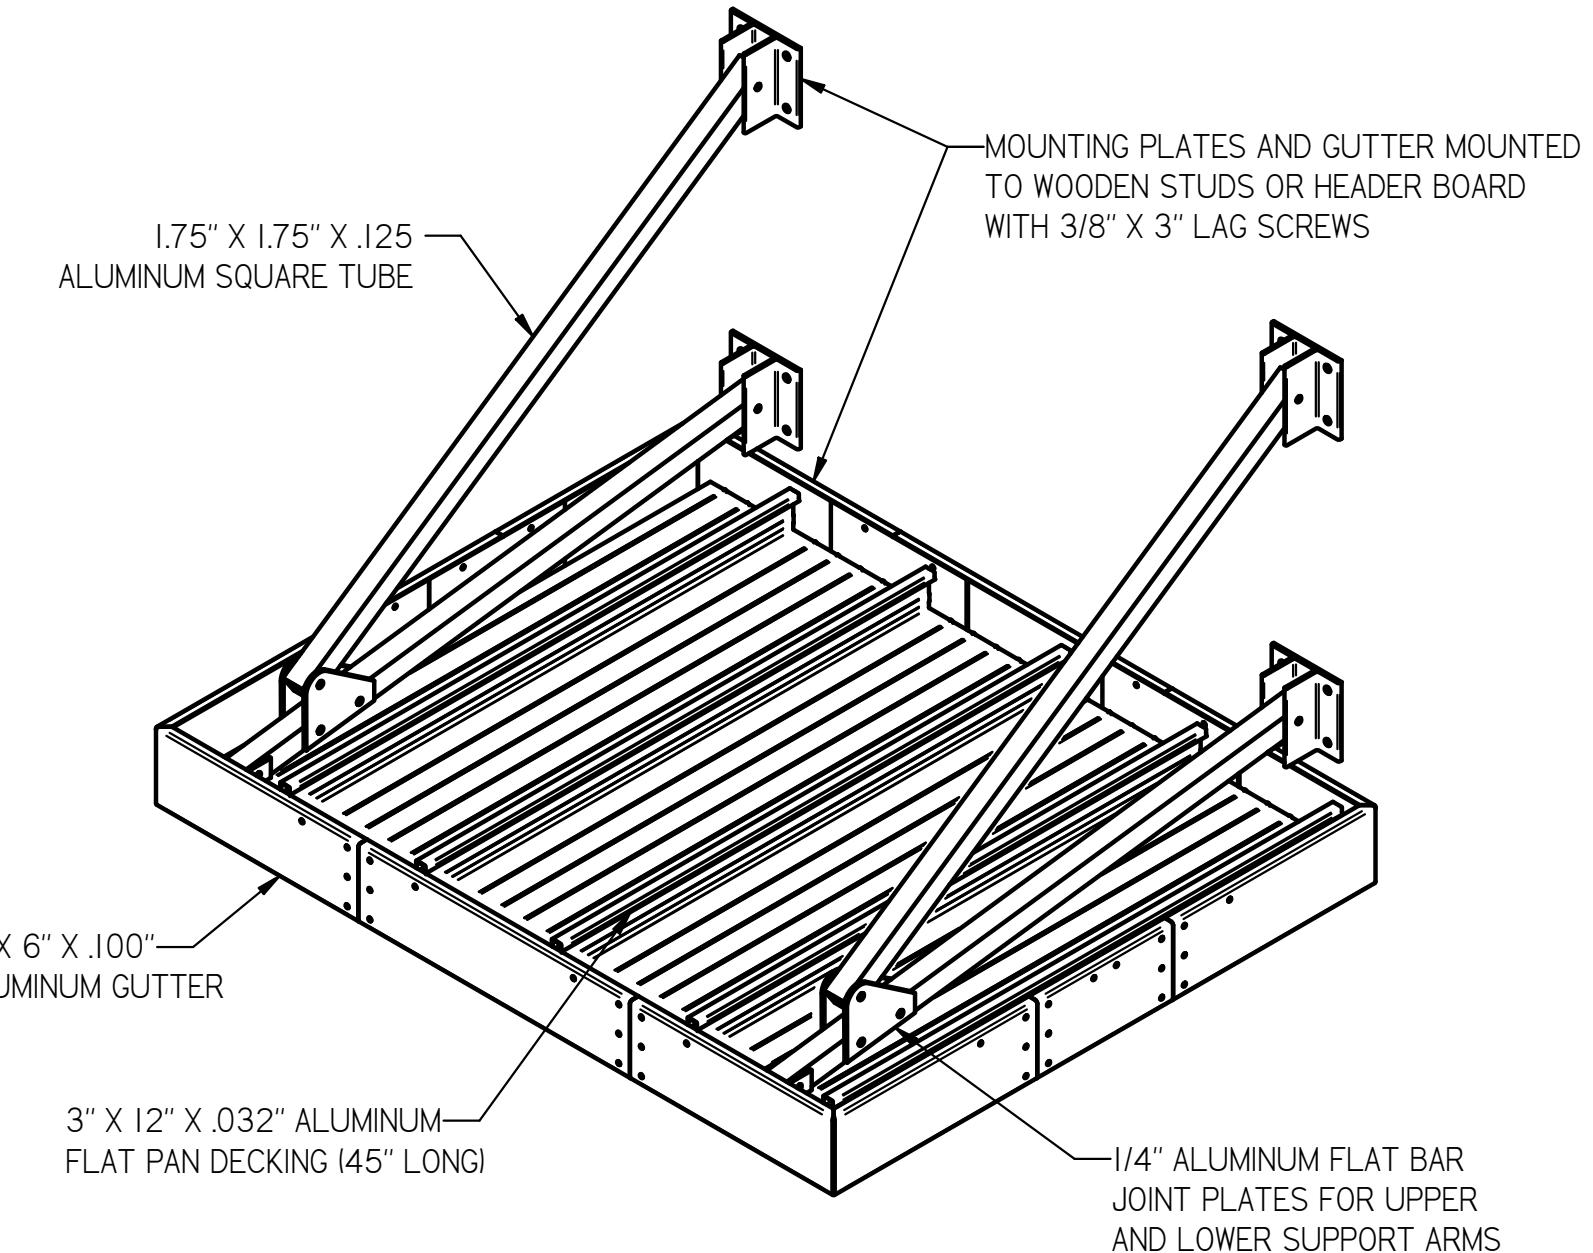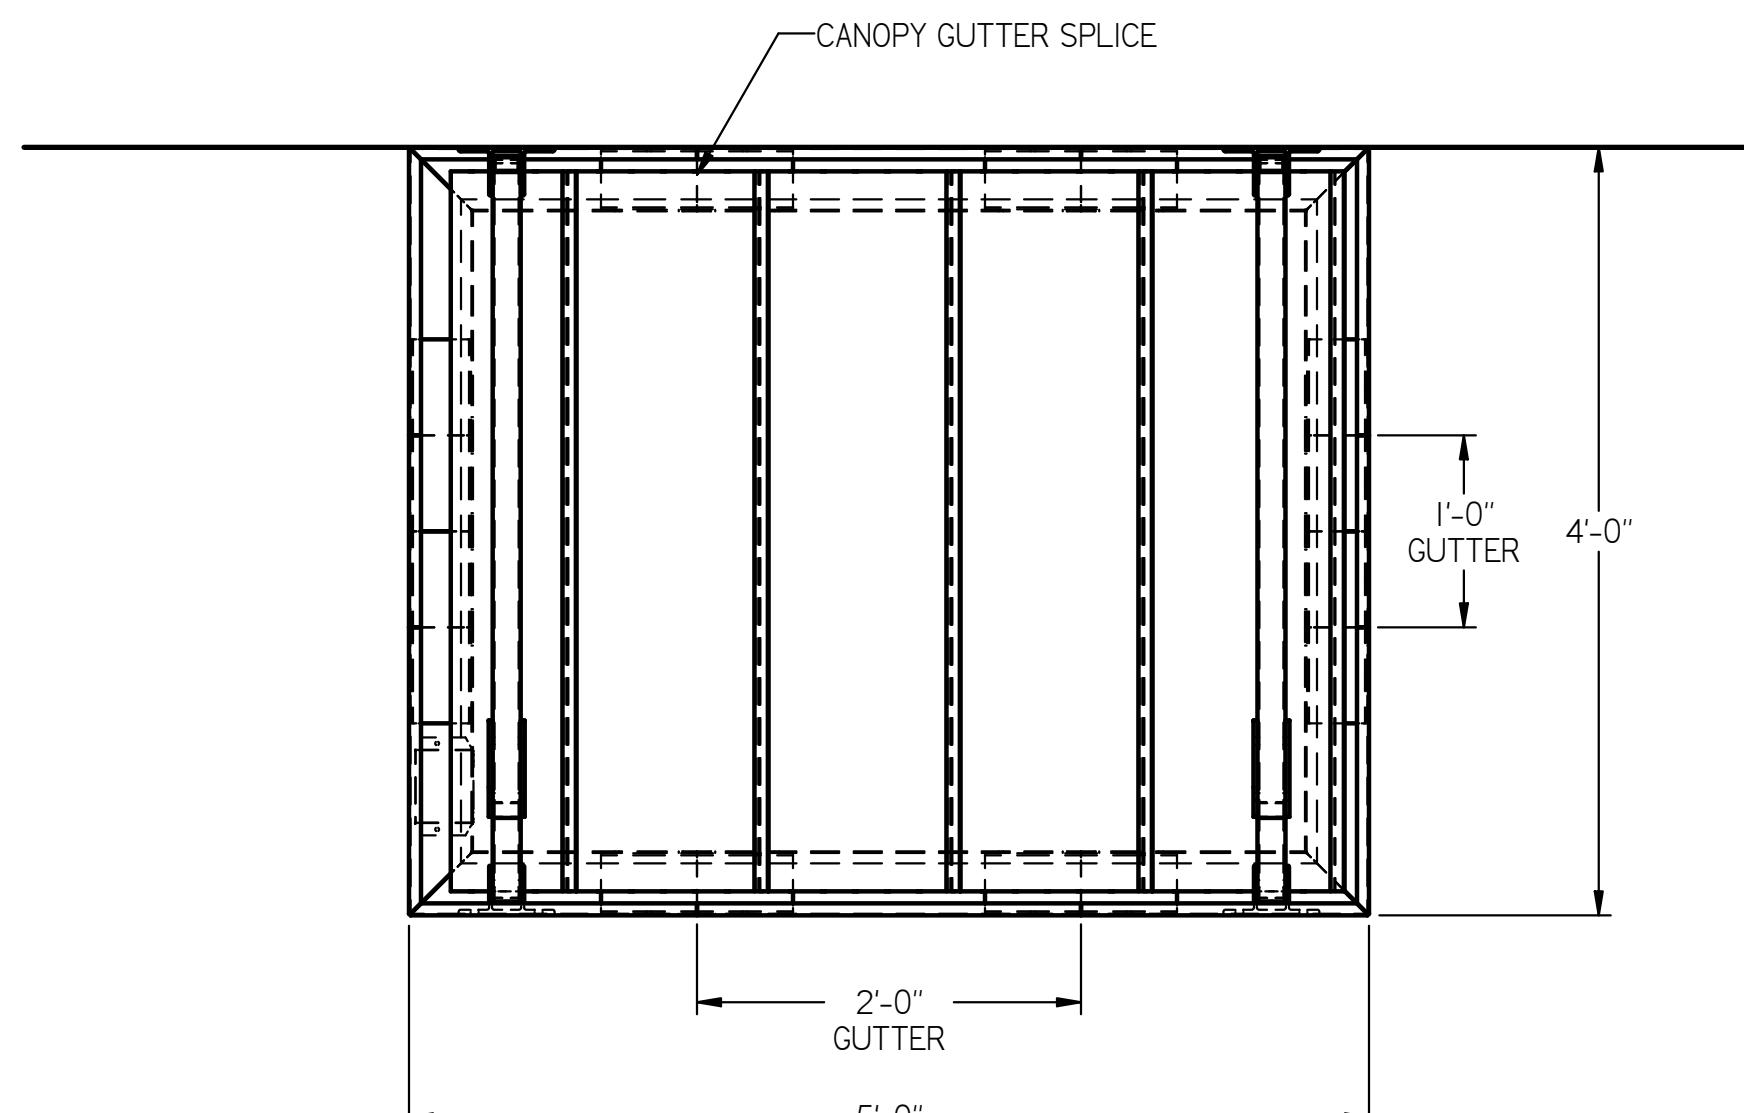

DRAIN SCUPPER CAN BE LOCATED ANYWHERE  
ALONG GUTTER DURING INSTALLATION

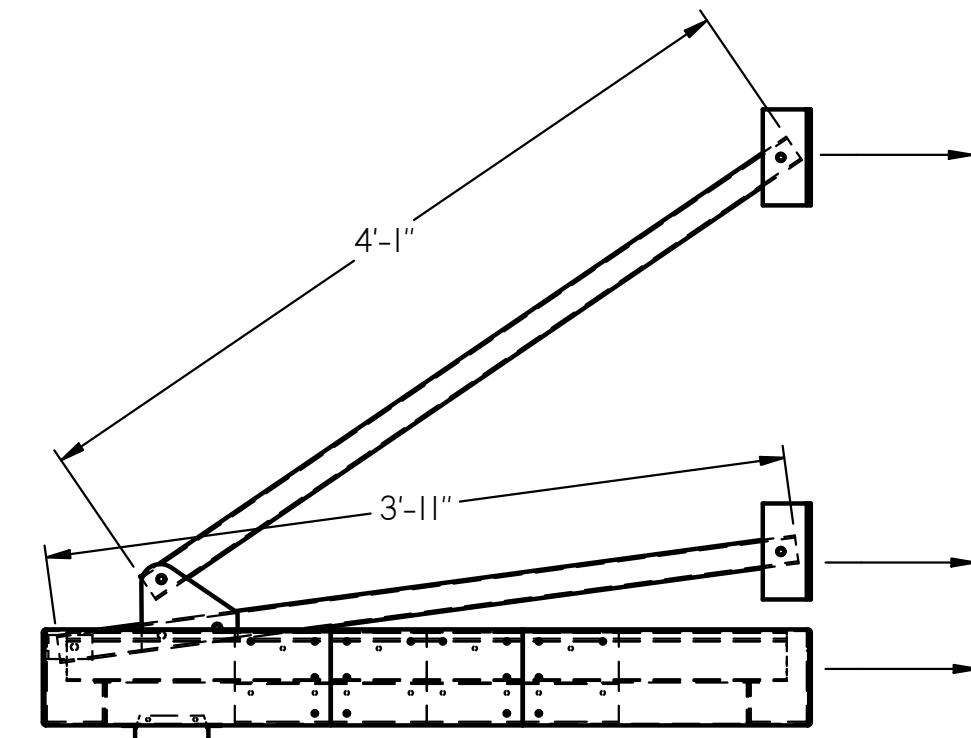

CANOPY MUST  
BE ANCHORED  
TO BUILDING  
THROUGH  
GUTTER FRAME  
AS WELL AS  
SUPPORT  
BRACKETS




## NOTES.

NOTES:

- I. CANOPY POWDER COATED WHITE.
2. ALL ALUMINUM CONSTRUCTION WITH STAINLESS STEEL HARDWARE. LAG SCREWS OR WEDGE ANCHORS AND TEK SCREWS ARE GALVANIZED STEEL.
3. APPROXIMATE WEIGHT AS SHOWN: 80 LBS.



CANTILEVER CANOPY CONNECTION DETAILS

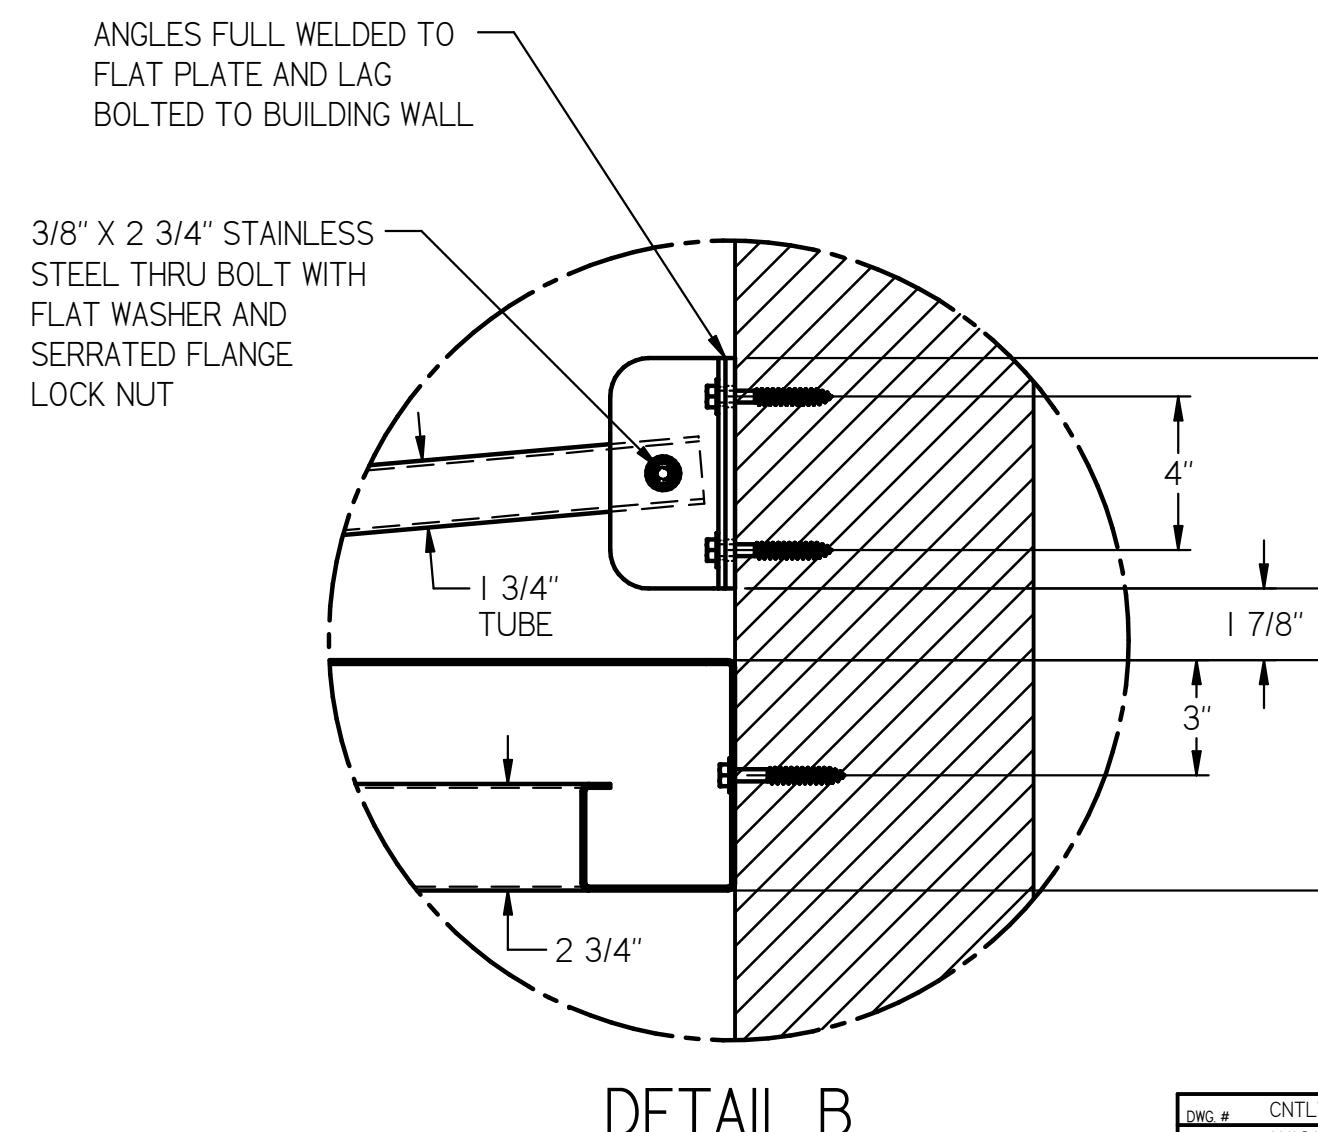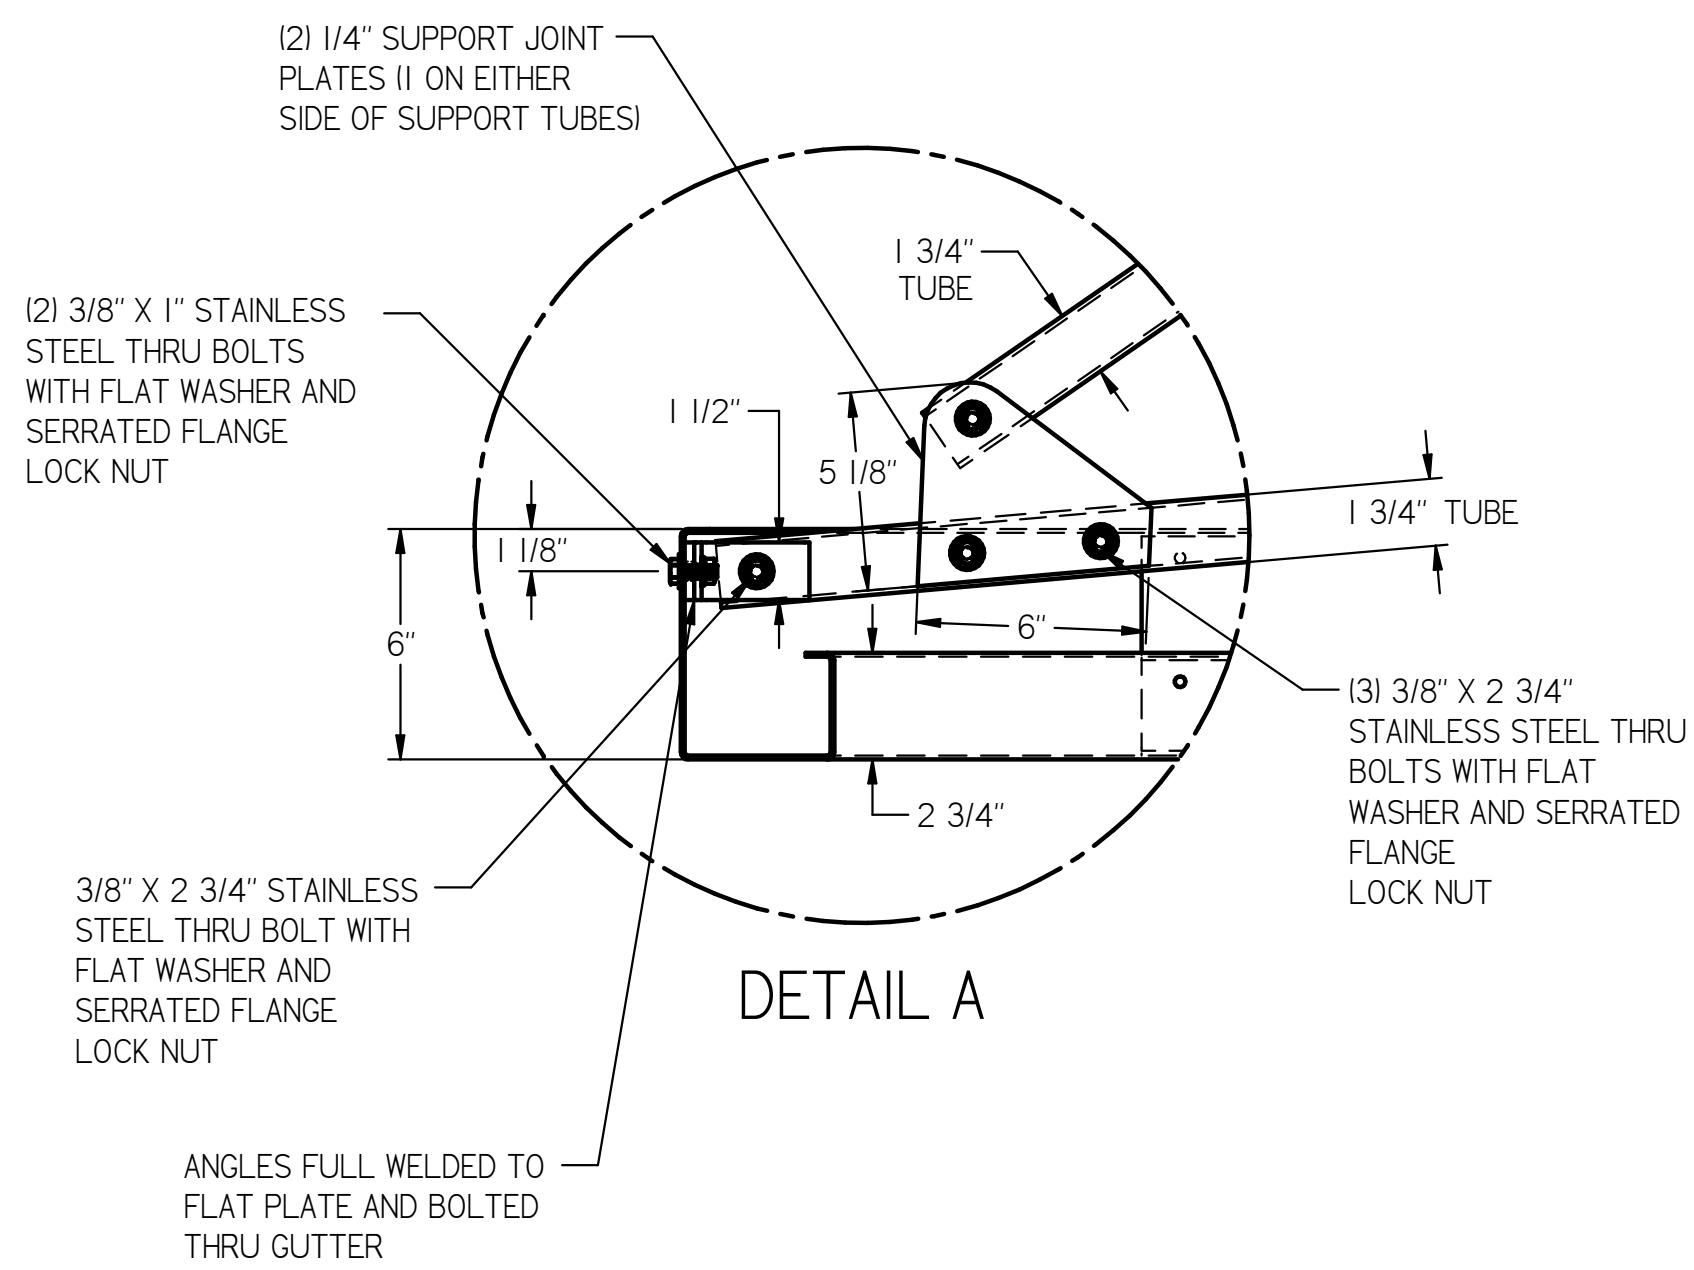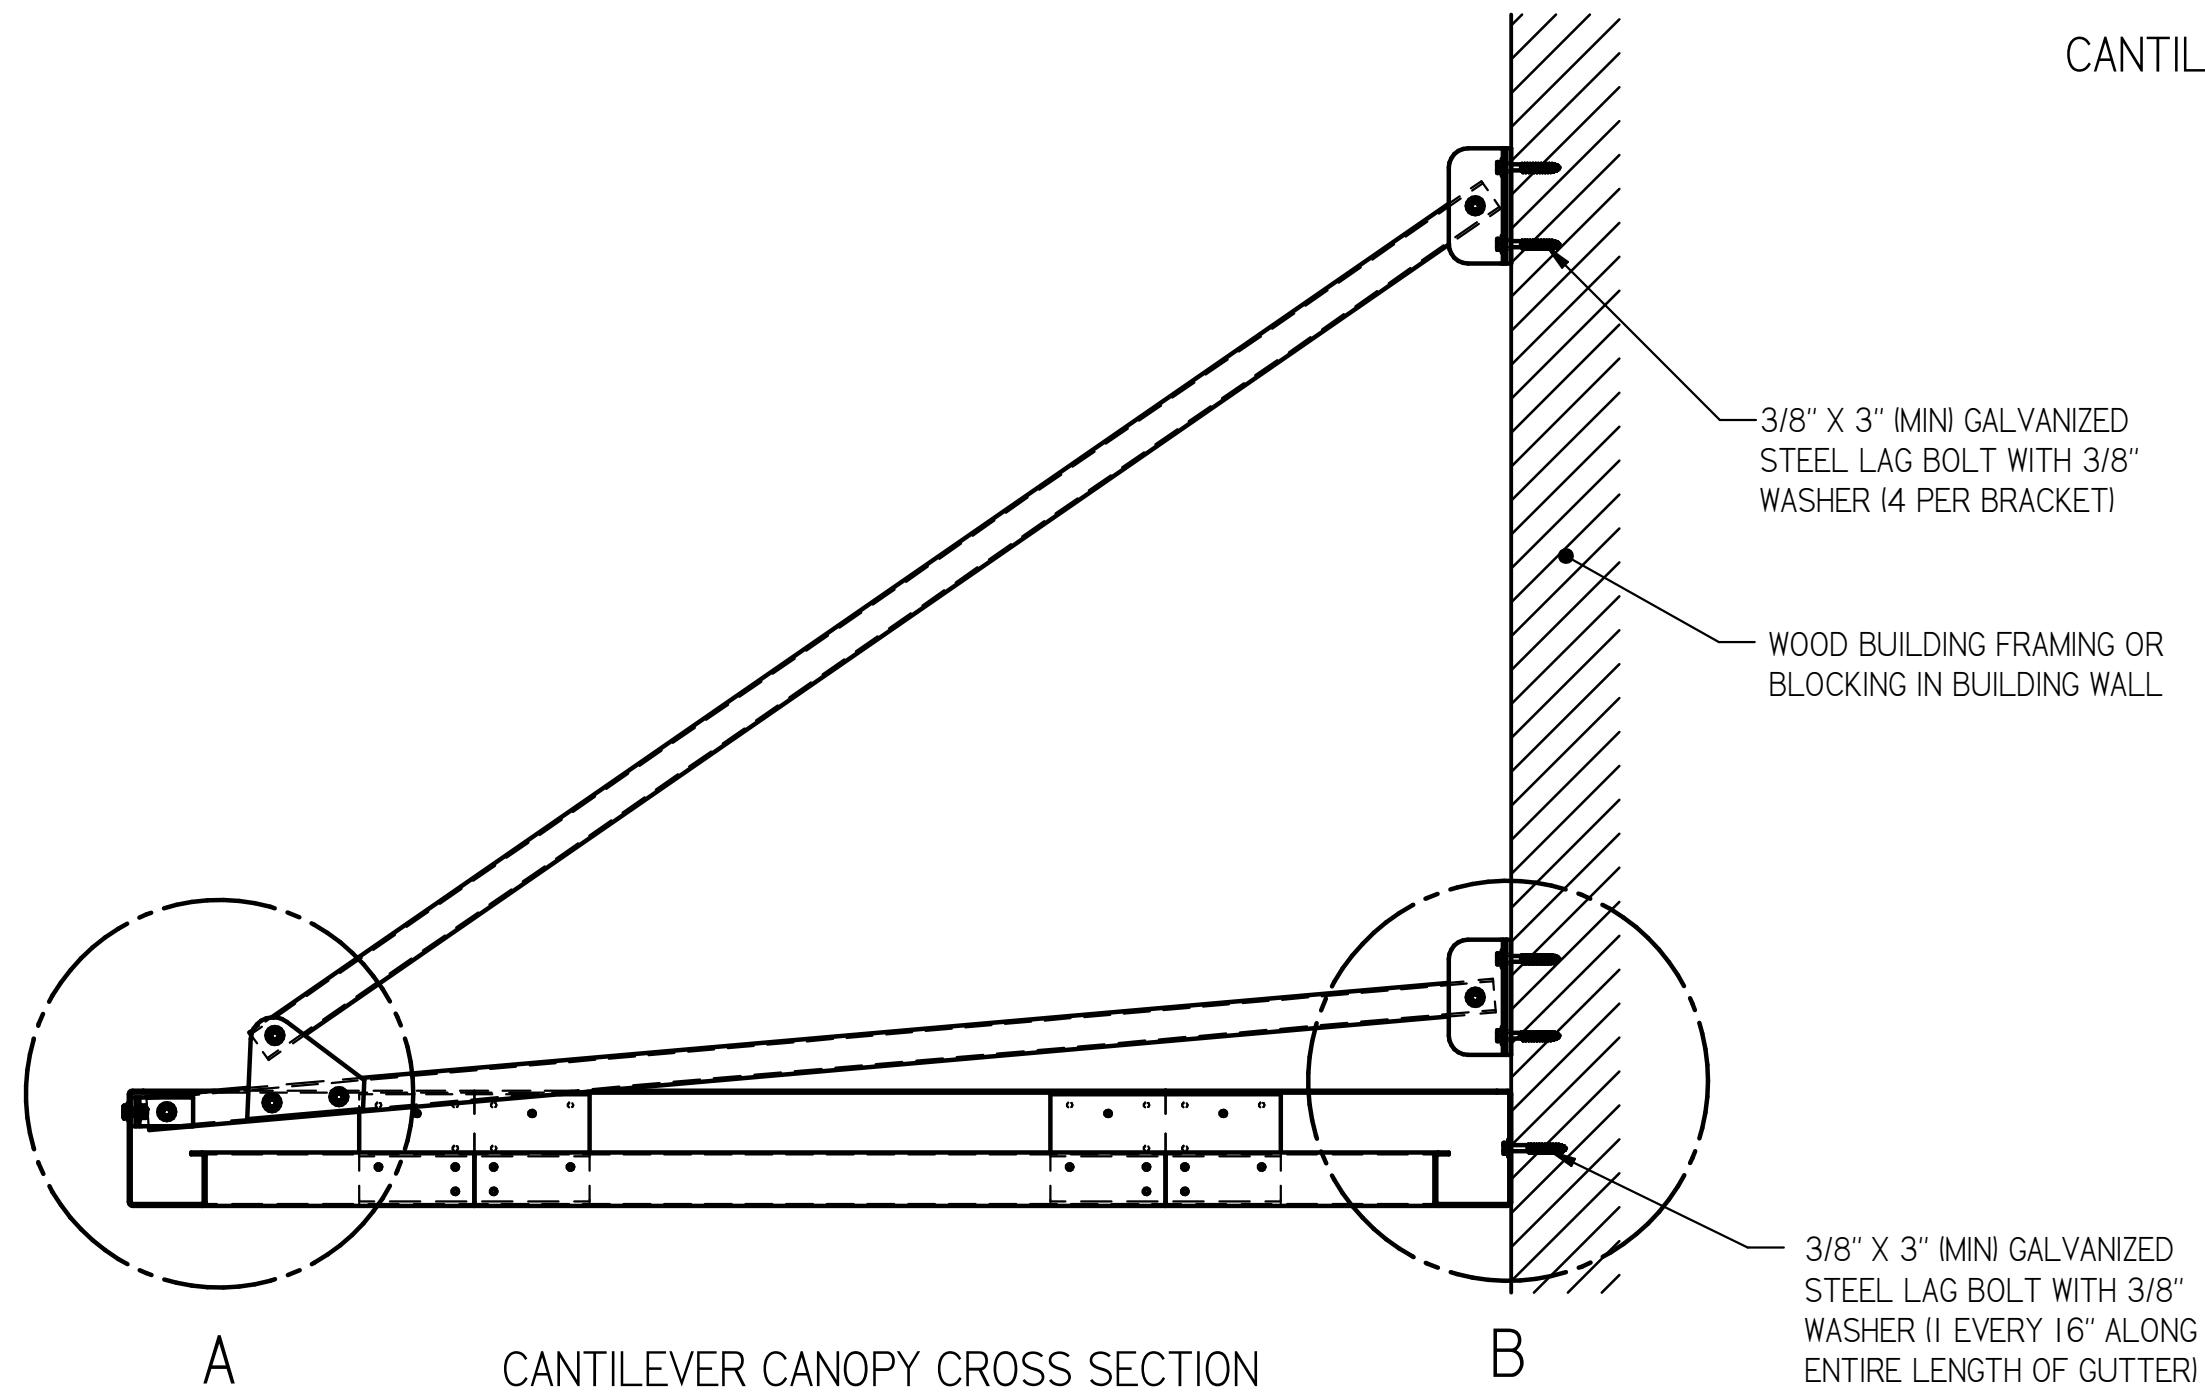

|          |                                      |  |              |
|----------|--------------------------------------|--|--------------|
| DWG #    | CNTLVR CONN                          | ALL DIMENSIONS IN INCHES<br>UNLESS OTHERWISE SPECIFIED | XXX ± 0.060" |
| DATE     | 11/13/18                             | XXXX ± 0.015"  | ANGLES ± 1"  |
| REVISION | --                                   |  |              |
| SCALE    | 1:10                                 |  |              |
| DRAWN    | SRF                                  |  |              |
| CHECKED  | KRS                                  |  |              |
| TITLE    | CANTILEVER CANOPY CONNECTION DETAILS | SIZE   | C            |
| DATE     | BY REV                               | REVISION DESCRIPTION                                   |              |
|          |                                      |  |              |
|          |                                      |  |              |
|          |                                      |  |              |
|          |                                      |  |              |

UPSIDE INNOVATIONS LLC  
CINCINNATI, OHIO  
WWW.UPSIDEINNOVATIONS.COM  
PHONE: (513) 889-2492 FAX: (513) 672-2124

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## PREFABRICATED ALUMINUM OVERHEAD SUPPORTED CANOPY

### PART 1 – GENERAL

#### 1.1 References

- 1.1.1 International Building Code (IBC) for all applicable snow and wind load requirements.

#### 1.2 Submittals

- 1.2.1 Shop Drawings: detailed shop drawings to be submitted upon receipt of purchase order including:
  - 1.2.1.1 Overall layout dimensions
  - 1.2.1.2 Footer layout drawings when requested
- 1.2.2 Warranty Statement must be submitted with bid.
- 1.2.3 Engineering: Professional Engineering sealed drawings to be submitted when requested.

#### 1.3 Quality Assurance

- 1.3.1 Acceptable manufacturer: Upside Innovations, LLC, 5470 Spellmire Dr., West Chester, OH 45246. Phone: (513) 889-2492; Fax: (513) 672-2124 or a contract manufacturer as approved by the Upside Innovations, LLC, Supplier Quality Review process.
- 1.3.2 Aluminum welding will be in accordance with ANSI / AWS D1.2/D1.2M: 2008. Welding must be performed solely with Pulsed Gas Metal Arc Welding (Pulse-MIG) processes or Gas Tungsten Arc Welding (TIG) processes by experienced operators.
- 1.3.3 All exposed surfaces must be free of sharp or jagged surfaces.
- 1.3.4 Warranty: Upside Innovations, LLC warrants its products to be free from defects in material and workmanship for a period of one year beginning at the date of delivery of product. This warranty excludes any defects resulting from abnormal use in installation, service, accidental or intentional damage or any occurrences beyond the manufacturer's control.

#### 1.4 Materials

- 1.4.1 Aluminum decking is constructed of 3004-H36 aluminum alloy or 6063-T6 mill finish with powder coating.
- 1.4.2 To attach the canopy to a building with wood blocking, use 3/8" galvanized steel lag bolts. To attach the canopy to a concrete or brick building, use 3/8" galvanized steel sleeve anchors.
- 1.4.3 To secure canopy decking to the gutter system, use #12 X 1" galvanized steel Tek Screws.
- 1.4.4 Available decking options consist of aluminum Extruded Flat Pan or Roll Formed Flat Pan.
- 1.4.5 All anchors and lag bolts are galvanized steel. All Tek screws are galvanized steel.
- 1.4.6 Silicone sealant must be applied to all gutter joints for a watertight seal.
- 1.4.7 White powder coating is standard. Custom colors are available upon request.

#### 1.5 Engineering

- 1.5.1 Aluminum canopy system is designed in accordance with the International Building Code's snow and wind requirements.

### PART 2 – PRODUCT COMPONENTS

#### 2.1 Canopy Decking

- 2.1.1 The decking options are Extruded Flat Pan (3" X 6" X .065") or Roll Formed Flat Pan (2.5" X 12" X .032") and shall interlock together to create a leak-proof joint.
- 2.1.2 Decking panels must be attached to the inner flange of the gutters with (2) #12 X 1" Tek screws with neoprene washers at both ends.
- 2.1.3 Canopy decking is cut to custom lengths to accommodate the desired projection of the walkway canopy up to 5'.

#### 2.2 Gutter System

- 2.2.1 All canopies are designed with an internal drainage system. The water is directed from the canopy decking into the gutter system that lines both sides of the canopy. A 2" – 3" drain hole will be



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drilled into the bottom of the gutter and a scupper plate will be installed to direct the water away from

- 2.2.2 Canopy gutter has a 6" fascia and is 4" wide with a thickness of 0.100".
- 2.2.3 The gutter is cut to a specific length that is dependent on the canopy design.
- 2.2.4 Gutter sections are connected using a 12" long x 0.125" thick canopy gutter splice and (14) galvanized #12 Tek screws at each joint.
- 2.2.5 Gutter corners are made of 18" X 18" pre-welded aluminum corners and are connected to the gutters using 12" long x 0.125" thick gutter splices with (14) galvanized #12 Tek screws.
- 2.2.6 Canopy gutters that mount to a building utilize 3/8" lag bolts and flat washers every 18".
- 2.2.7 When the canopy is designed with back-to-back gutters, the gutters must be connected using (2) 3/8" X 1" stainless steel bolts every 18".
- 2.2.8 Scupper plates located on the sides of the canopy provide drainage out of the canopy gutter.

**2.3 Overhead Support System**

- 2.3.1 Canopy overhead support arms are constructed with 1-3/4" x 1-3/4" x 0.125" aluminum square tube and shall include both an upper and lower support arm.
- 2.3.2 Wall brackets will be constructed with aluminum angles used to connect and through-bolt into the support arms.

**2.4 Fasteners**

- 2.4.1 All framing fasteners shall be #12 x 1" galvanized steel tek screws with neoprene washers
- 2.4.2